


**ABBREVIATIONS**

AB	AND
AB	ANCHOR BOLT
ABV	ABOVE
AC	AIR CONDITIONING
AD	AREA DRAIN
ADDL	ADDITIONAL
ADJ	ADJUSTABLE
AFF	ABOVE FINISHED FLOOR
AHU	AIR HANDLING UNIT
ALUM	ALUMINUM
AP	ACCESS PANEL
ARCH	ARCHITECTURAL
BD	BOARD
BLDG	BUILDING
BLKG	BLOCKING
BLW	BELOW
B.O.	BOTTOM OF
CAB	CABINET
CONT.	CONTINUOUS
CL	CENTER LINE
CL	CENTER LINE
CLD	CERILING
CLO	CLOSET
CLR	CLEAR
CMU	CONCRETE MASONRY UNIT
CU	CONDENSING UNIT
CO	CARBON MONOXIDE DETECTOR
COL	COLUMN
CONC	CONCRETE
CONSTR	CONSTRUCTION
CONT	CONTINUOUS
CONTR	CONTRACTOR
CONTR	CENTER
CTR	DEEP
D	DOUBLE
DBL	DOUBLE
DK	DIAMETER
DM	DIMENSION
DN	DOWN
DR	DOOR
DS	DOWN SPOUT
DTL	DETAIL
DW	DISHWASHER
DWG	DRAWING
DWR	DRAWER
EACH	EACH
EA	EXHAUST FAN
EL	ELEVATION
ELEC	ELECTRICAL
ELEV	ELEVATOR
EP	ELECTRIC PANEL
EQ	EQUAL
EW	EACH WAY
EXP	EXPANSION
EXT	EXISTING
EXT	EXTERIOR
FF	FINISHED FLOOR
FIN	FINISH
FLR	FLOOR
FND	FOUNDATION
F.O.	FACE OF
FT	FEET
FTG	FOOTING
FUR	FURRING
G	GAUGE
GA	GALVANIZED
GALV	GALVANIZED
GND	GROUND
GPM	GALLONS PER MINUTE
GR	GRADE
GWB	GYPSPUM WALL BOARD
H	HIGH
HB	HOSE BIBB
HD	HEAD
HW	HARDWARE
HW	HARDWOOD
HT	HEIGHT
HVAC	HEATING, VENTILATION, AIR CONDITIONING
HWH	HOT WATER HEATER
IRC	INTERNATIONAL RESIDENTIAL CODE
IN	INCHES
ID	INSIDE DIAMETER
NCL	INCLUDED/INCLUDING
INSUL	INSULATION
INT	INTERIOR
J	JACK
JT	JOINT
L	LENGTH
LBS	POUNDS
MAS	MASONRY
MATL	MATERIAL
MAX	MAXIMUM
MDF	MEDIUM DENSITY FIBERBOARD
MECH	MECHANICAL
MFR	MANUFACTURER
MIN	MINIMUM
M.O.	MASONRY OPENING
MTL	METAL
NEW	NEW
N/A	NOT APPLICABLE
NIC	NOT IN CONTRACT
NO	NUMBER
NOM	NOMINAL
NTS	NOT TO SCALE
O.C.	ON CENTER
OD	OUTSIDE DIAMETER
OVHD	OVERHEAD
PNT/PNTD	PAINT / PAINTED
PL	PLATE
PLUM	PLUMBING
PLYWD	PLYWOOD
PR	PAIR
PSD	POUNDS PER SQUARE FOOT
PSI	POUNDS PER SQUARE INCH
P.T.	PRESSURE TREATED
R	RISER
RAD	RADIUS
REF	REFRIGERATOR
RENF	REINFORCED
REQD	REQUIRED
REV	REVISION
RM	ROOM
R.O.	ROUGH OPENING
S	SOUTH
SCHED	SCHEDULE
SD	SMOKE DETECTOR
SECT	SECTION
SF	SQUARE FEET
SHT	SHEET
SM	SIMILAR
SLVG	SALVAGE
SPEC	SPECIFICATION
SQ	SQUARE
STD	STANDARD
STL	STEEL
STRUC	STRUCTURE
TREAD	TREAD
TRD	TO BE DETERMINED
TEL	TELEPHONE
THK	THICK
THRESH	THRESHOLD
T.O.	TOP OF
TYP	TYPICAL
UNF	UNFINISHED
UNO	UNLESS NOTED OTHERWISE
UL	UNDERWRITERS LABORATORIES
VAN	VANITY
V.B.	VAPOR BARRIER
VTR	VENT THROUGH ROOF
W	WIDE
W	WITH
WC	WATER CLOSET
WD	WOOD
WD	WASHER / DRYER
WDW	WINDOW
W/O	WITHOUT
WP	WATERPROOF

**DRAWING STANDARDS**

**DIMENSION METHOD**

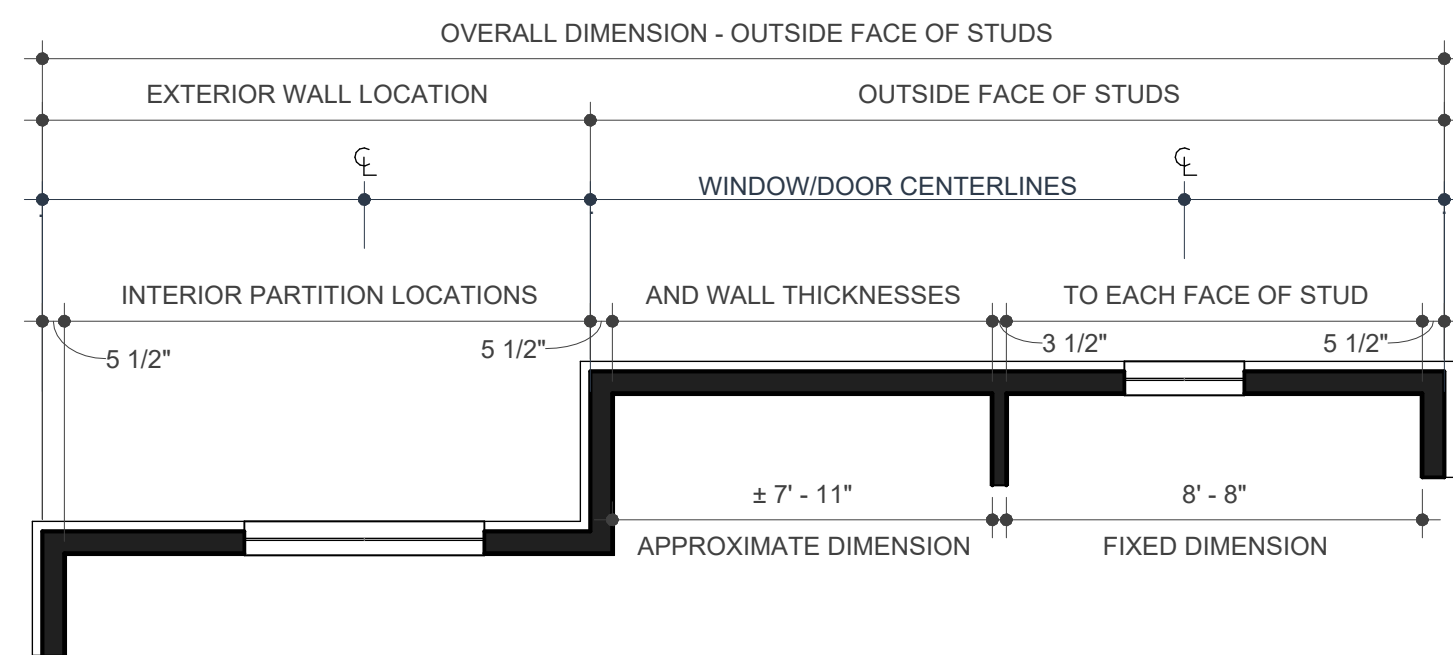

**DRAWING SYMBOLS**

**DOOR TAG**  
 DOOR NUMBER PER SCHEDULE  
 DOOR WIDTH

**WINDOW TAG**  
 WINDOW TYPE PER SCHEDULE

**ROOM TAG**  
 Room name  
 ROOM NUMBER PER SCHEDULE  
 ROOM AREA

**KEYNOTE**  
 KEYNOTE NUMBER, REFER TO SCHEDULE

**ALIGN FINISHED SURFACES**  
 ALIGN

**SECTION MARK**  
 DRAWING NUMBER  
 SHEET NUMBER

**STORY ELEVATION**  
 Name Elevation

**3D VIEW OF THE PROJECT**

**COMMON MATERIALS**

**PLAN CORRECTION**


**CODES**

**CODES**

CONSTRUCTION TYPE:

SPRINKLERS:

**CODE ANALYSIS**

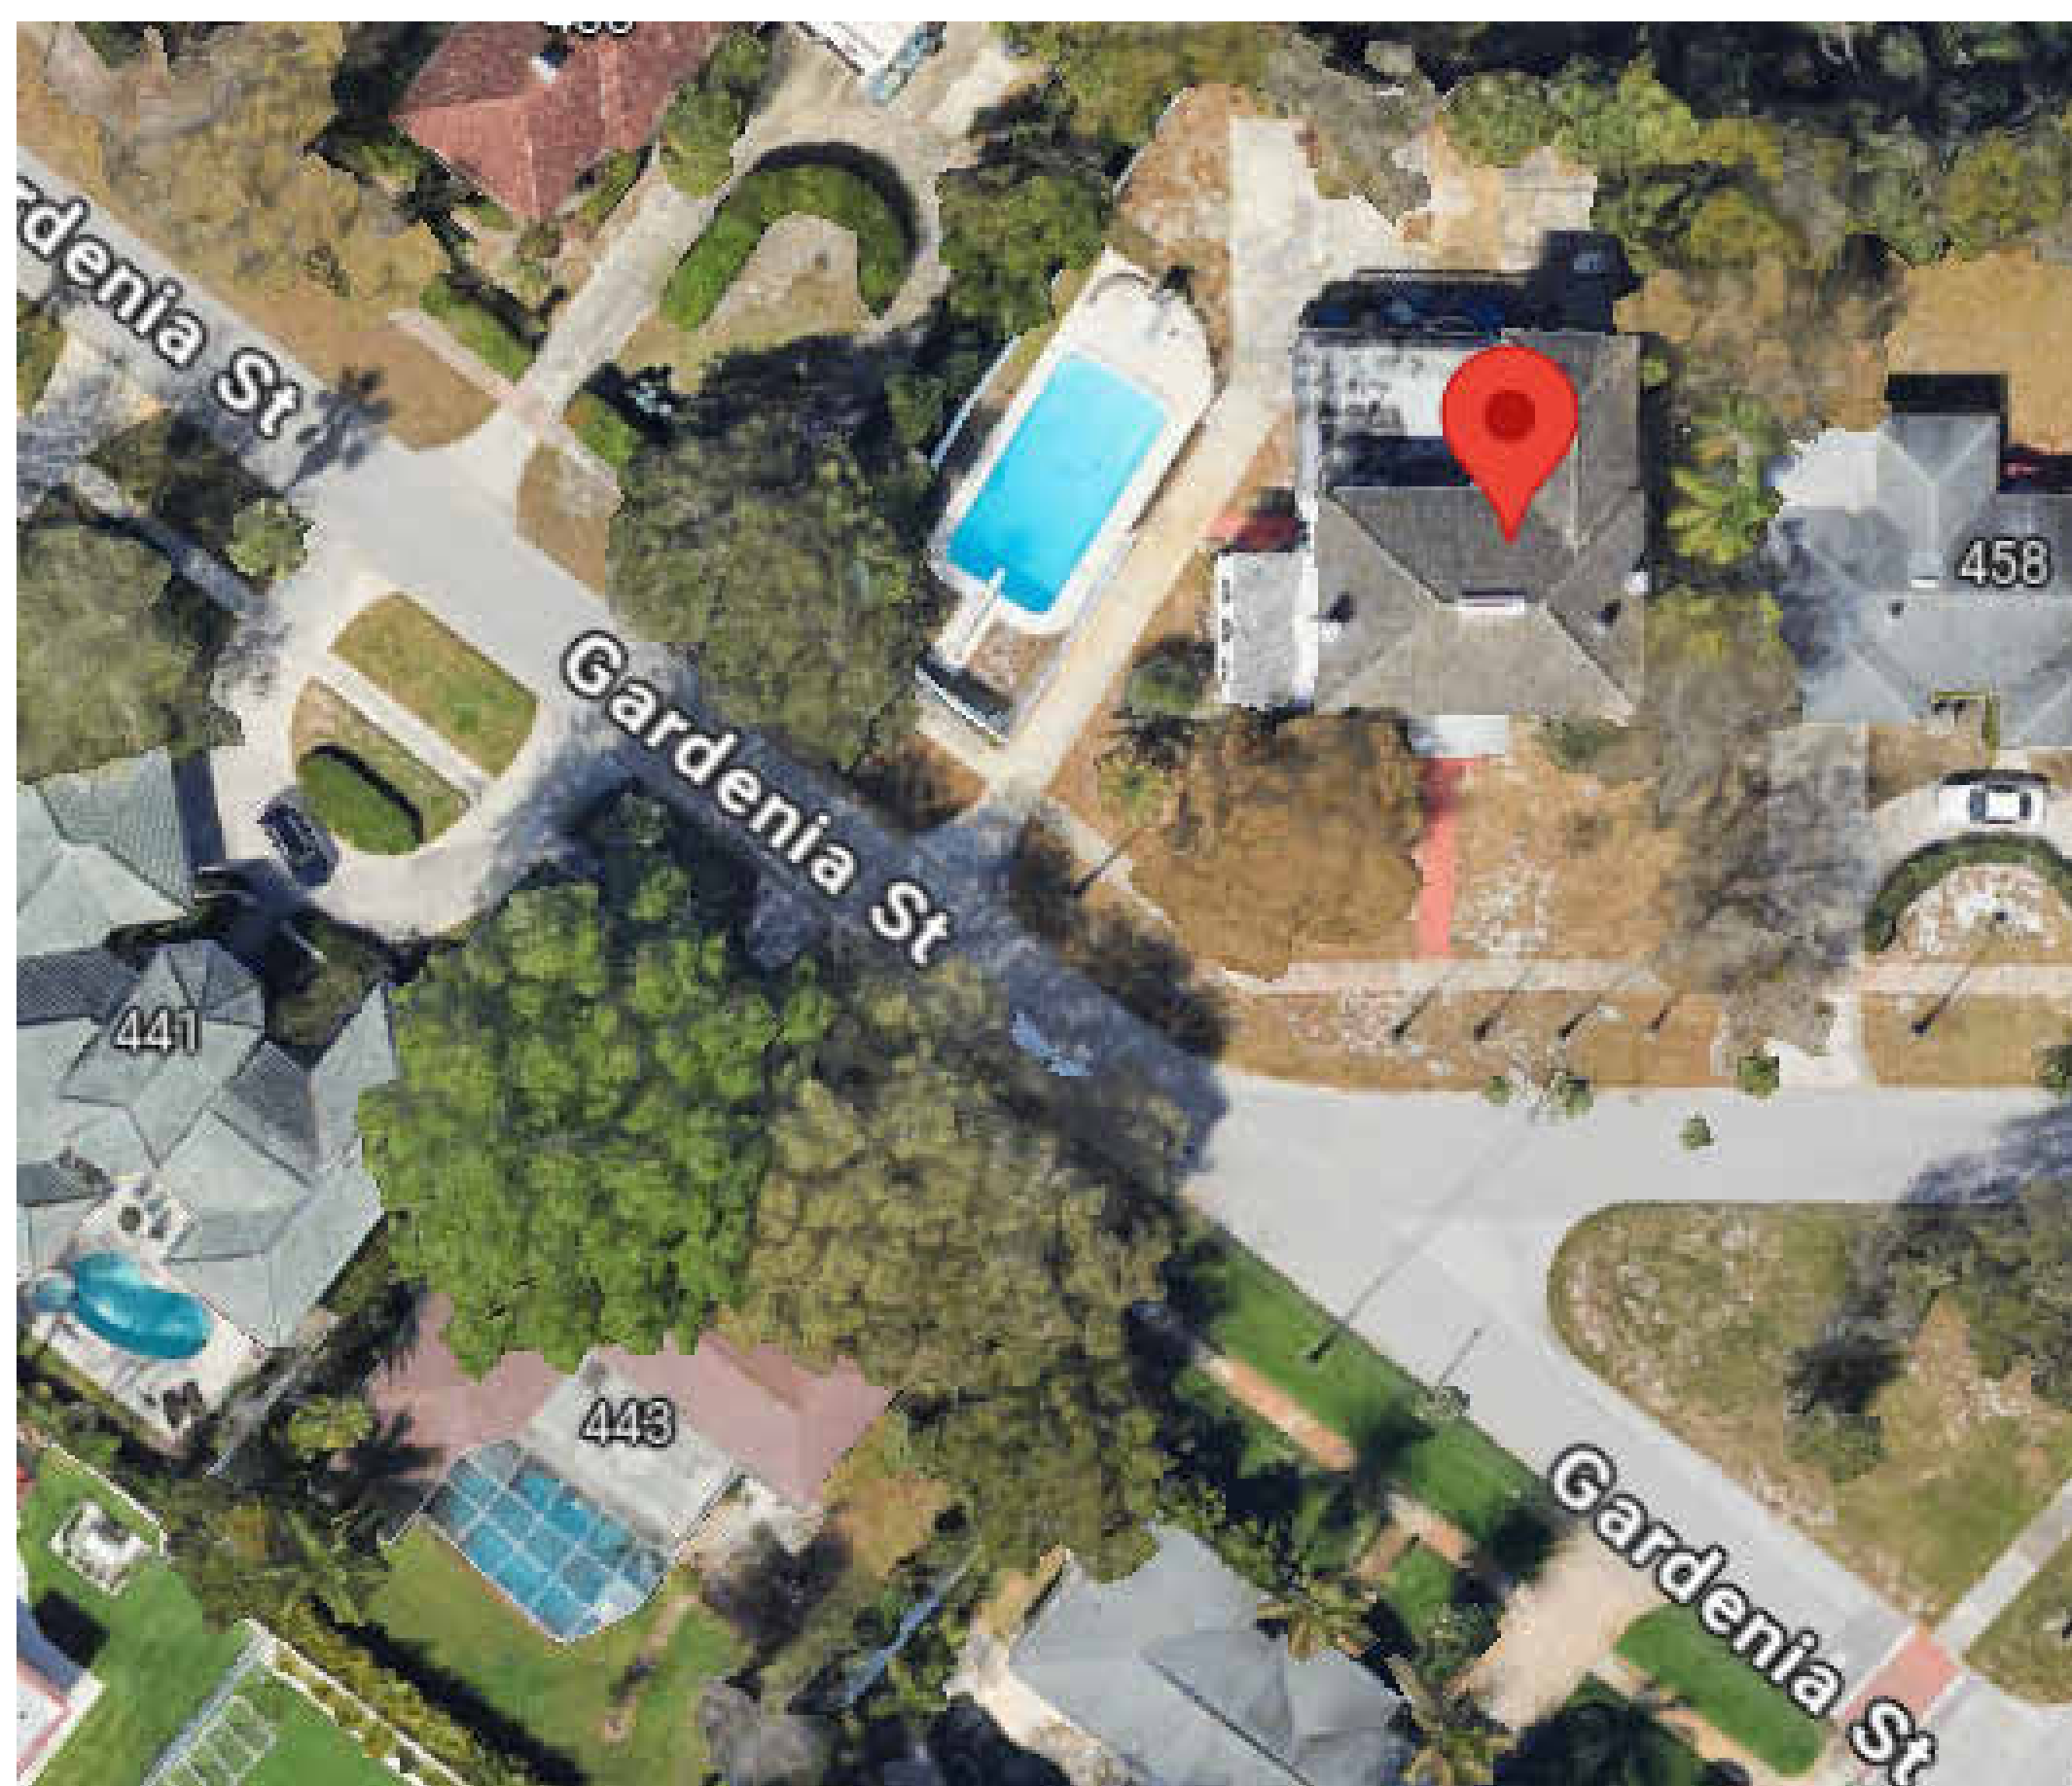

**DRAWING INDEX**

Sheet No.	Sheet Name	Revision Date
A100	COVER PAGE	
A101	FIRST FLOOR	
A102	CALLOUT	
A103	CALLOUT	
A104	CALLOUT	
A105	CALLOUT	
A106	SECOND FLOOR	
A107	CALLOUT	
A108	CALLOUT	

Architecture  
Engineering  
Urban Design  
Interior Design



**Project Location**

456 Gardenia  
St, 33756  
Belleair, FL,  
United  
States  
456  
Gardenia St

No.	Description	Date

**COVER PAGE**

Date APRIL 2024


Drawn by Aaron DESIGN

**A100**

Scale 1/4" = 1'-0"

**PROJECT LOCATION**



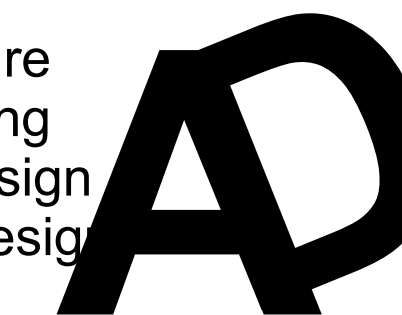

Project Location

456 Gardenia  
St, 33756  
Belleair, FL,  
United  
States  
456  
Gardenia St

No.	Description	Date

FIRST  
FLOOR


Date      APRIL 2024

Drawn by      Aaron DESIGN

A101

Scale      1/4" = 1'-0"



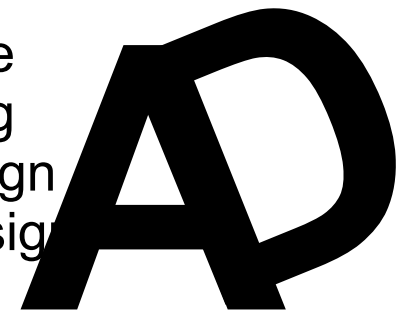

### Project Location

456 Gardenia St, 33756  
Belleair, FL,  
United States  
456 Gardenia St

No.	Description	Date


### CALLOUT

Date APRIL 2024

Drawn by Aaron DESIGN


# A102

Scale 1/2" = 1'-0"

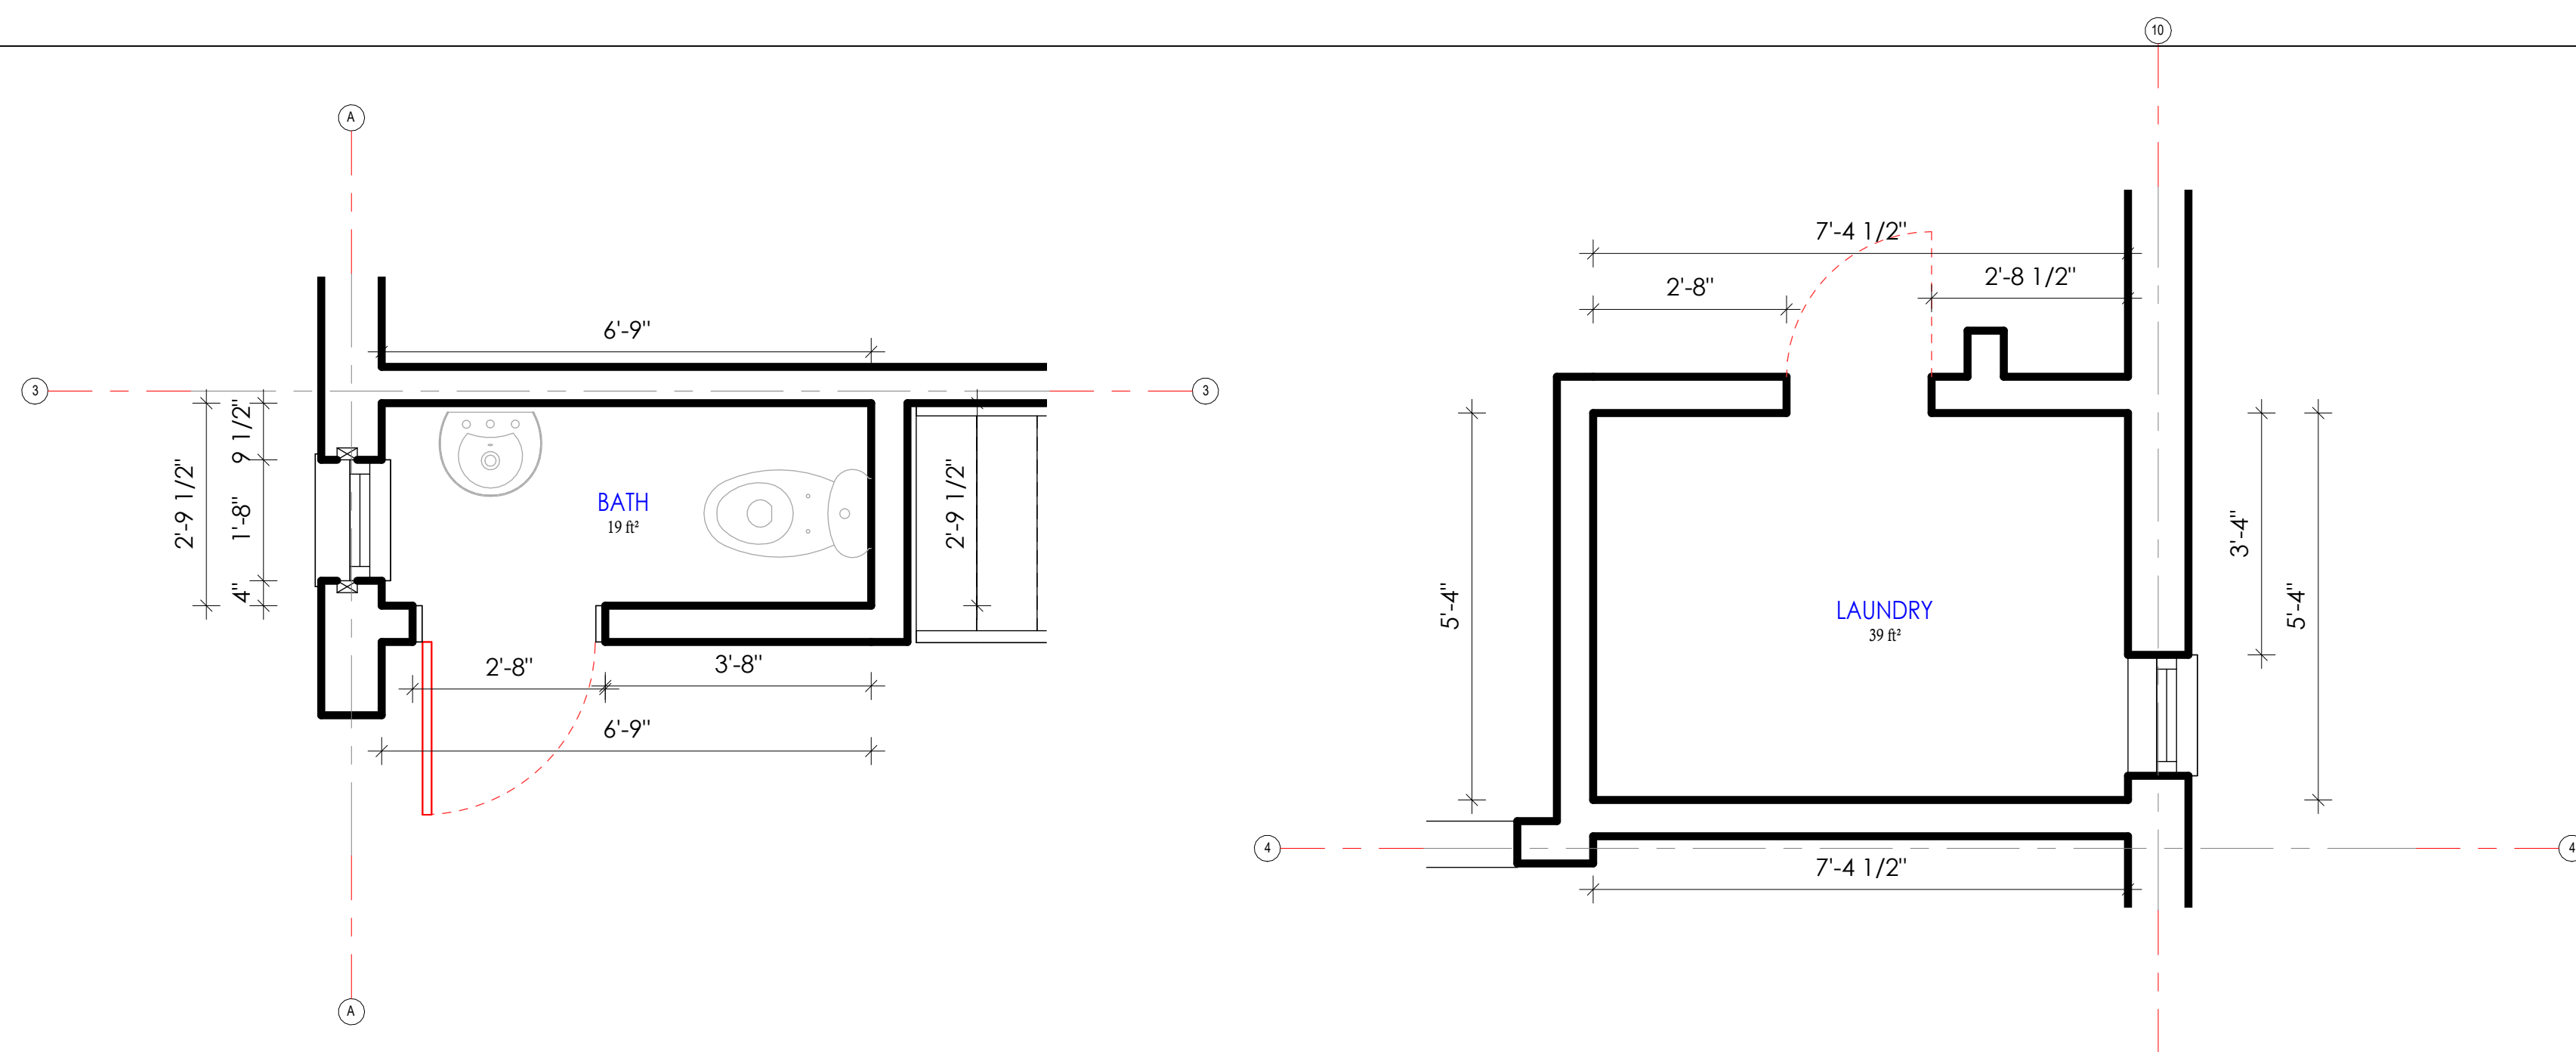


**1** 02 GROUND FLOOR PLAN - CALLOUT 1  
1/2" = 1'-0"


**2** 02 GROUND FLOOR PLAN - CALLOUT 2  
1/2" = 1'-0"

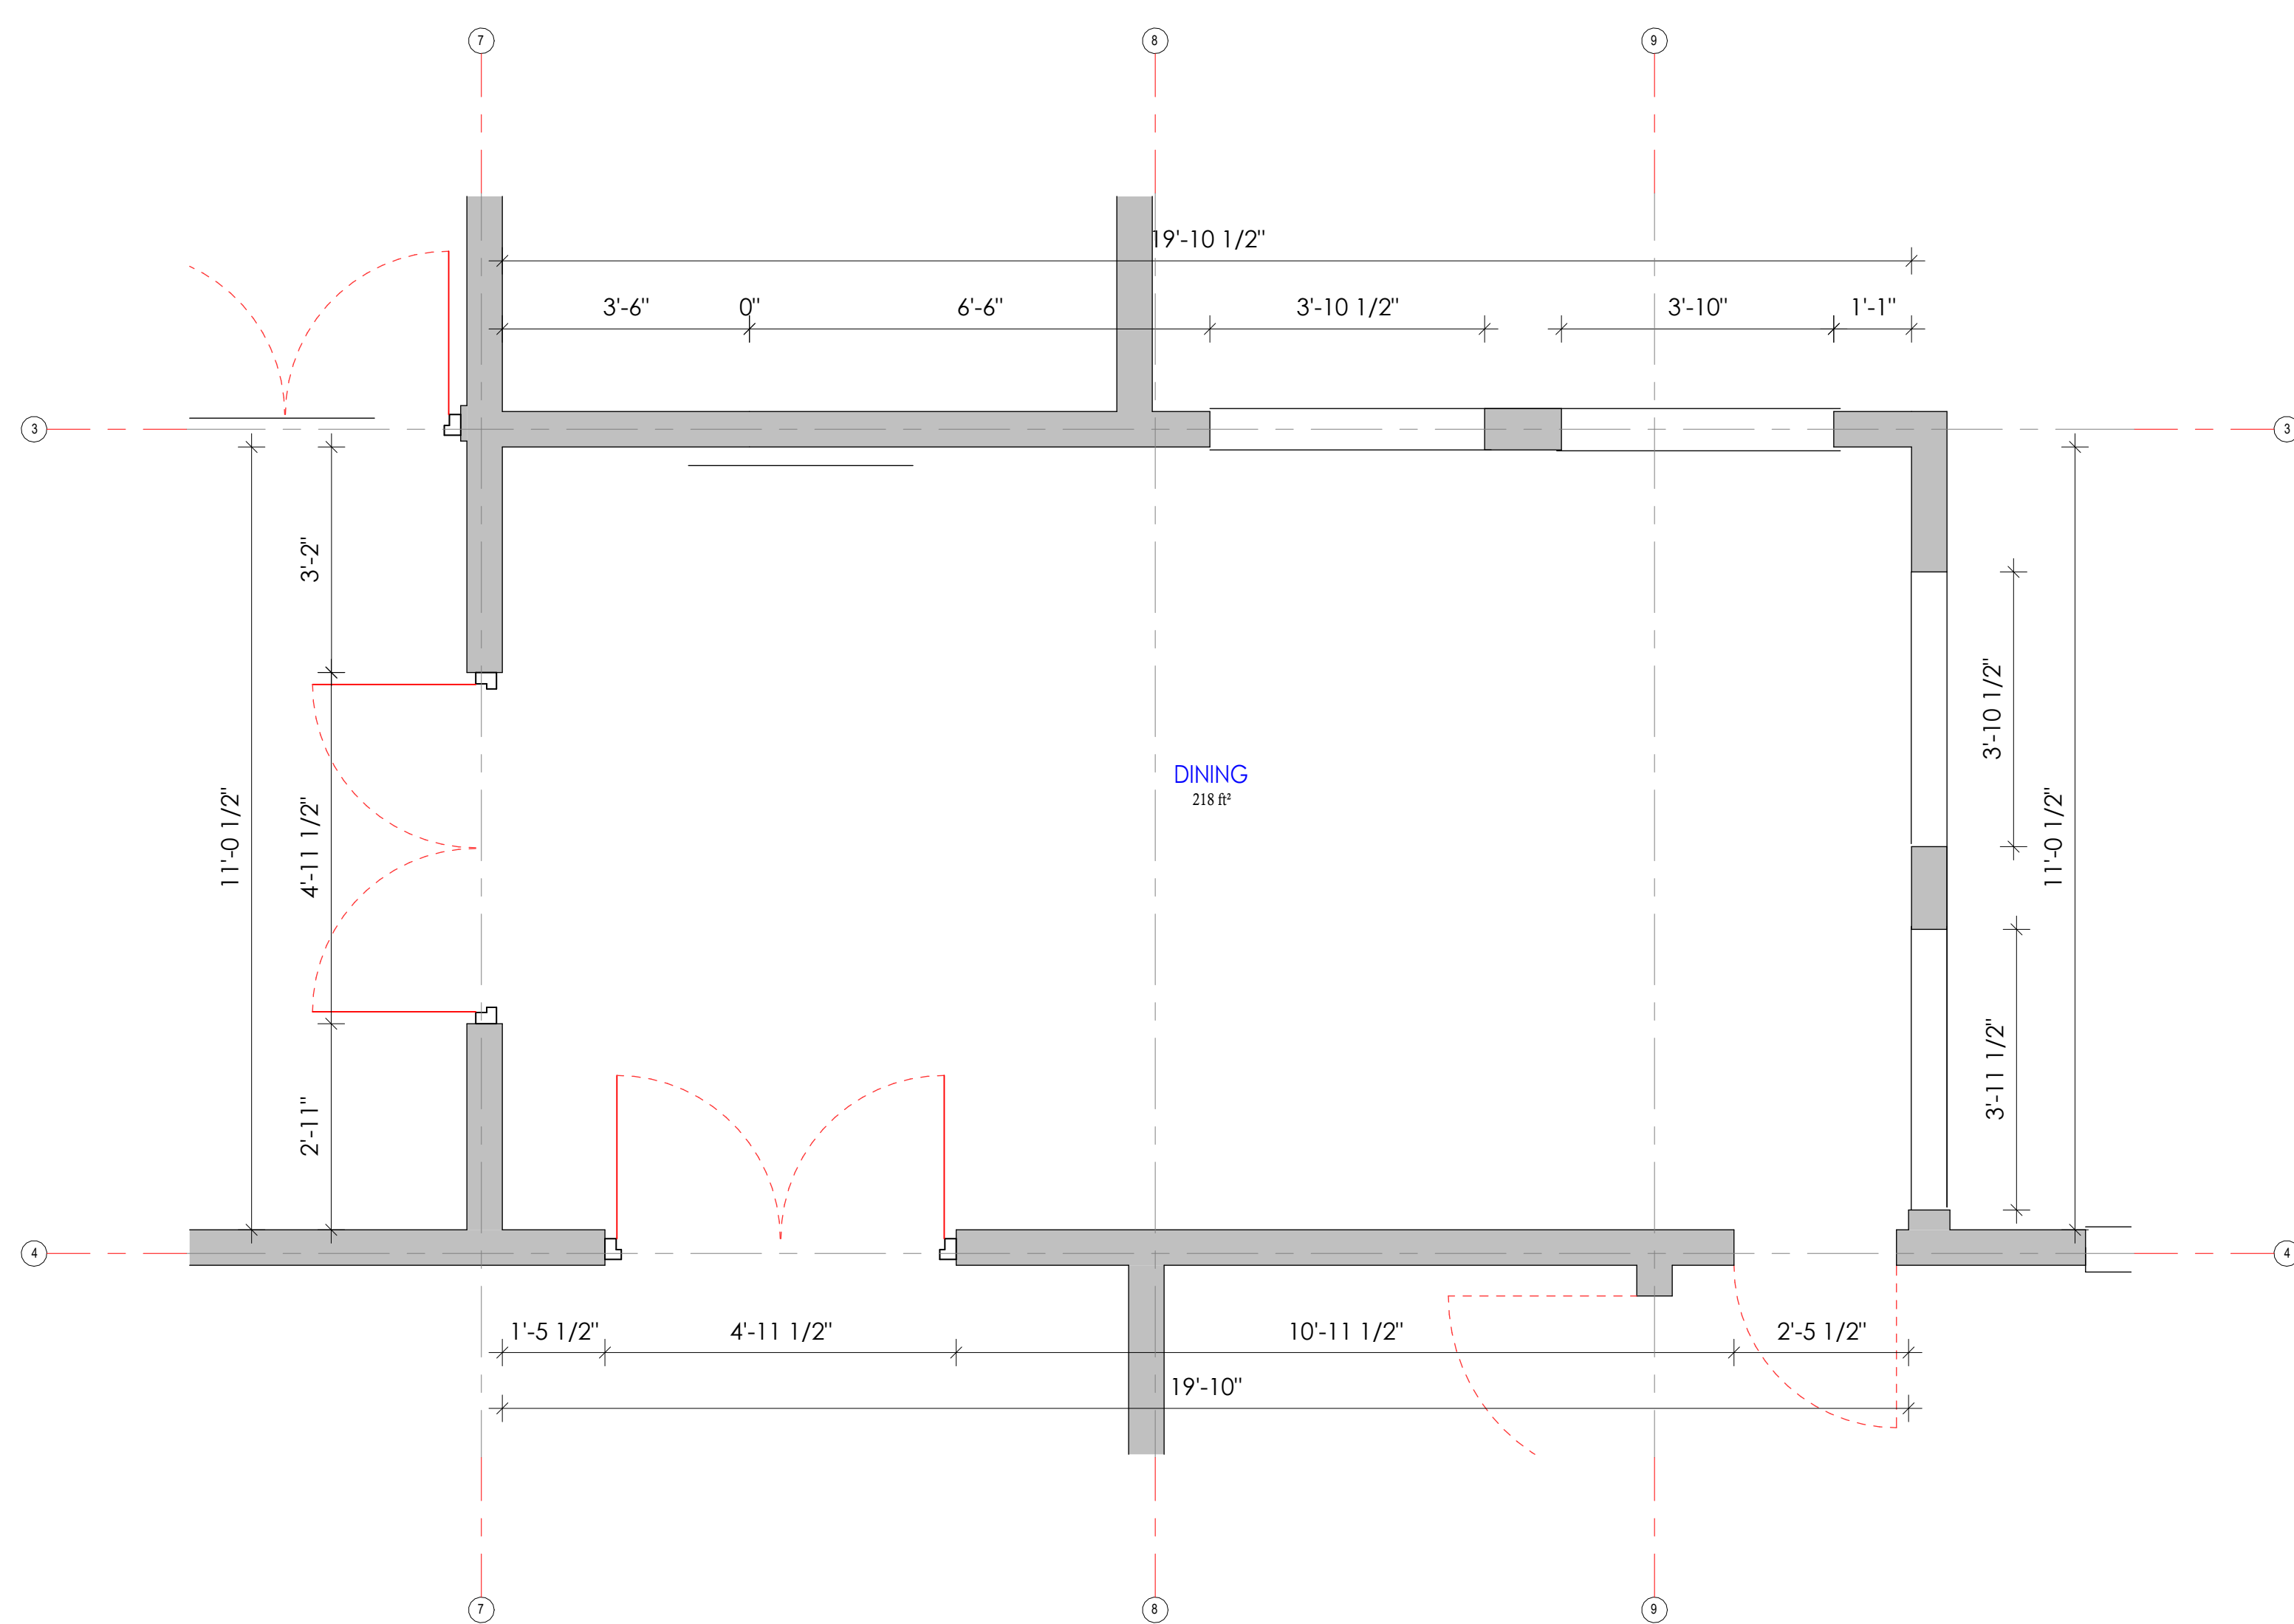

**3** 02 GROUND FLOOR PLAN - CALLOUT 3  
1/2" = 1'-0"

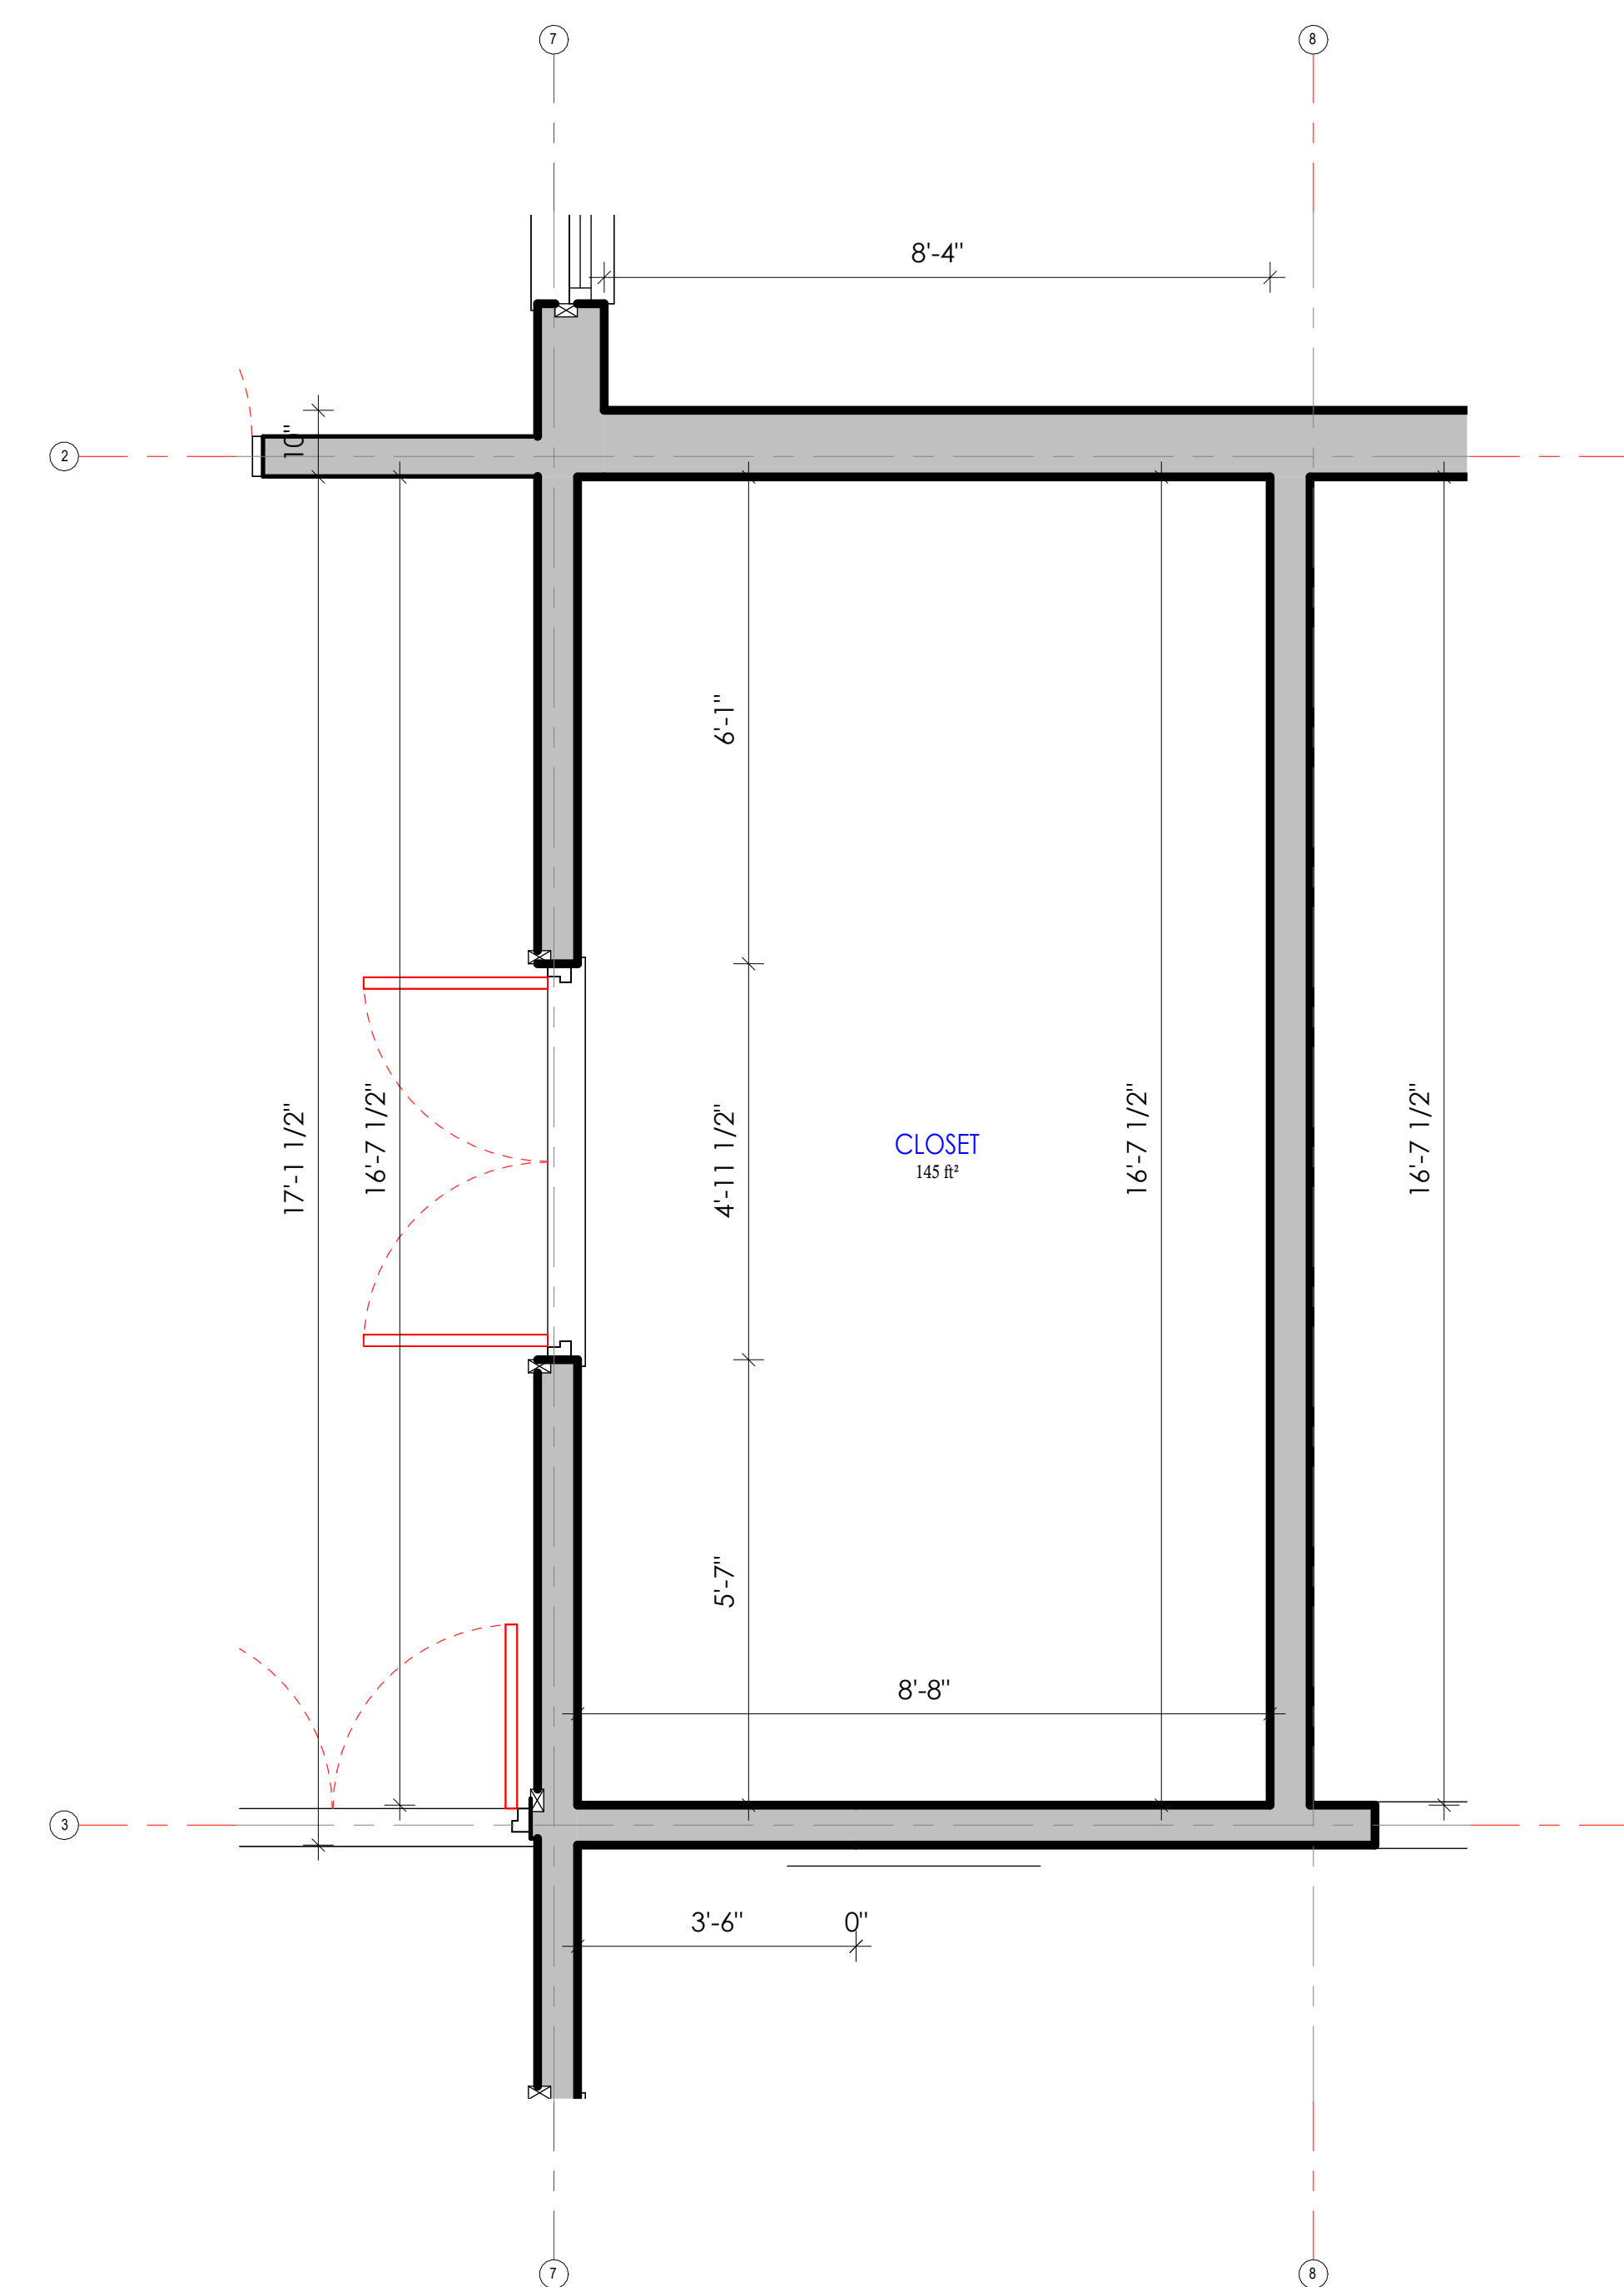


**4** 02 GROUND FLOOR PLAN - CALLOUT 4  
1/2" = 1'-0"

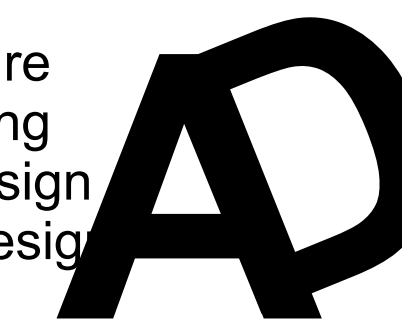

obiggi2023@gmail.com

### Project Location

456 Gardenia  
 St, 33756  
 Belleair, FL,  
 United  
 States  
 456  
 Gardenia St

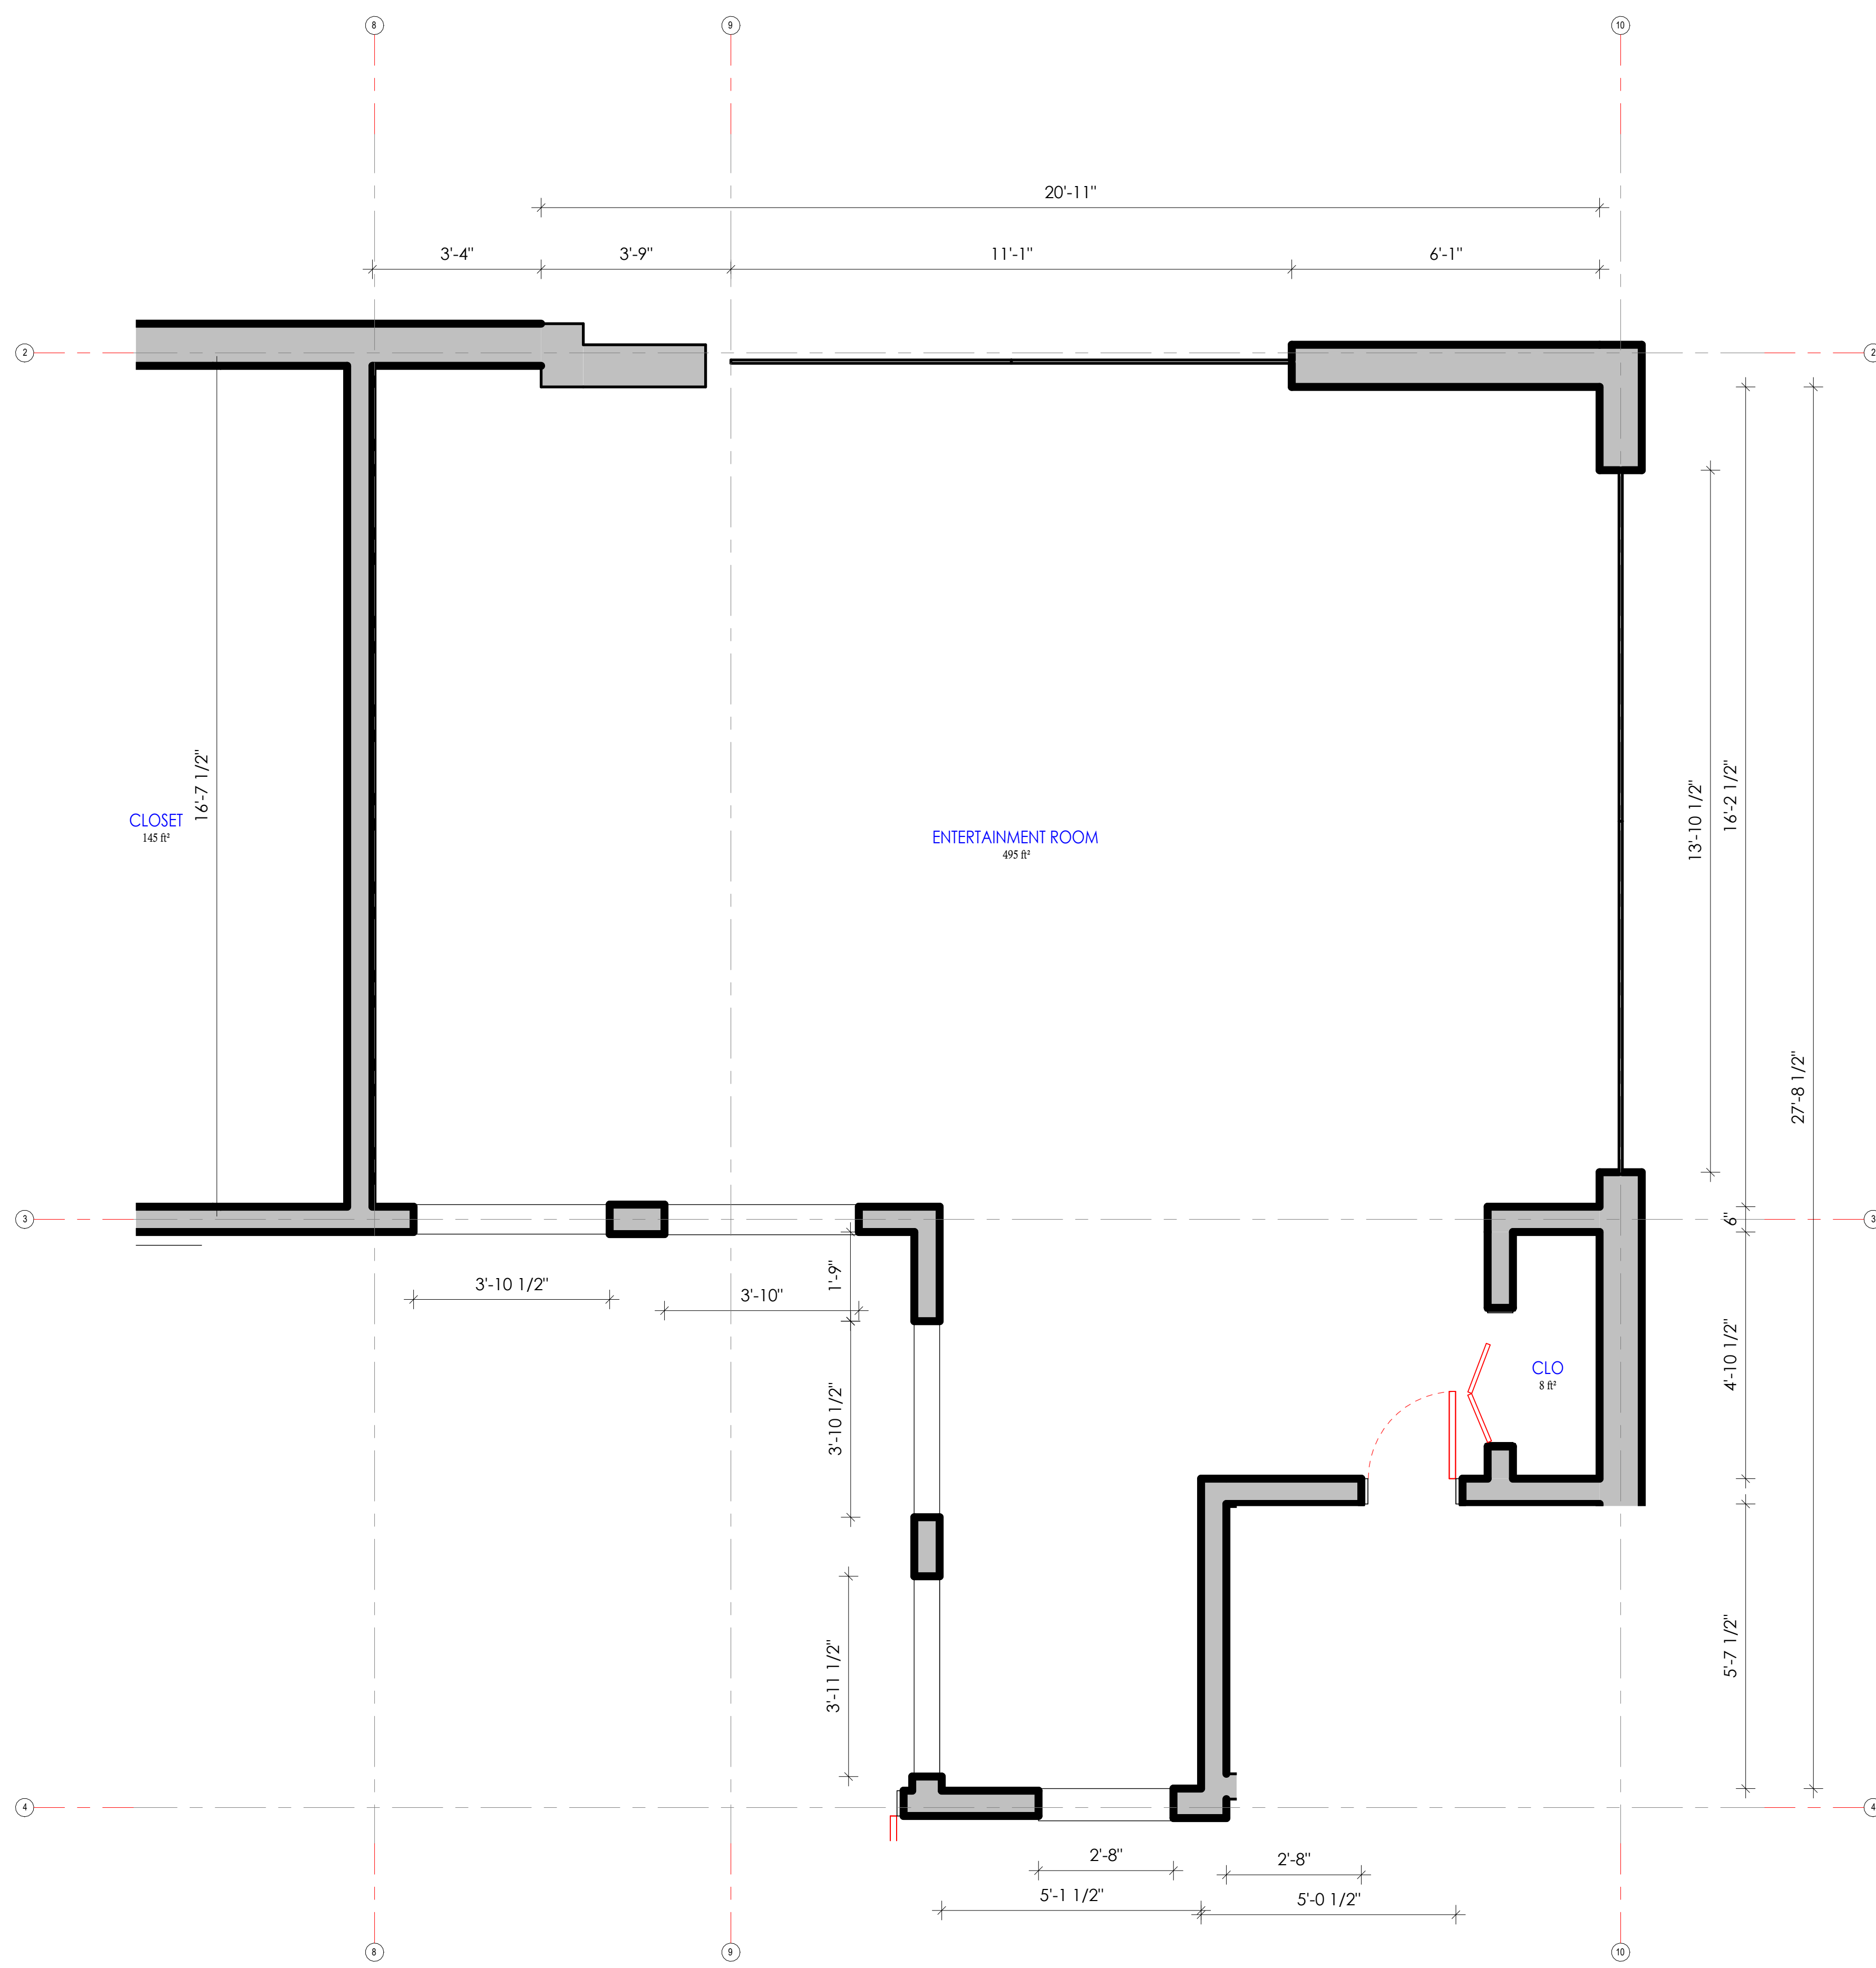

**02 GROUND FLOOR PLAN - CALLOUT 5**  
 1/2" = 1'-0"

No.	Description	Date

### CALLOUT

Date APRIL 2024


Drawn by Aaron DESIGN

# A103


Scale 1/2" = 1'-0"

Project Location

456 Gardenia  
St, 33756  
Belleair, FL,  
United  
States  
456  
Gardenia St

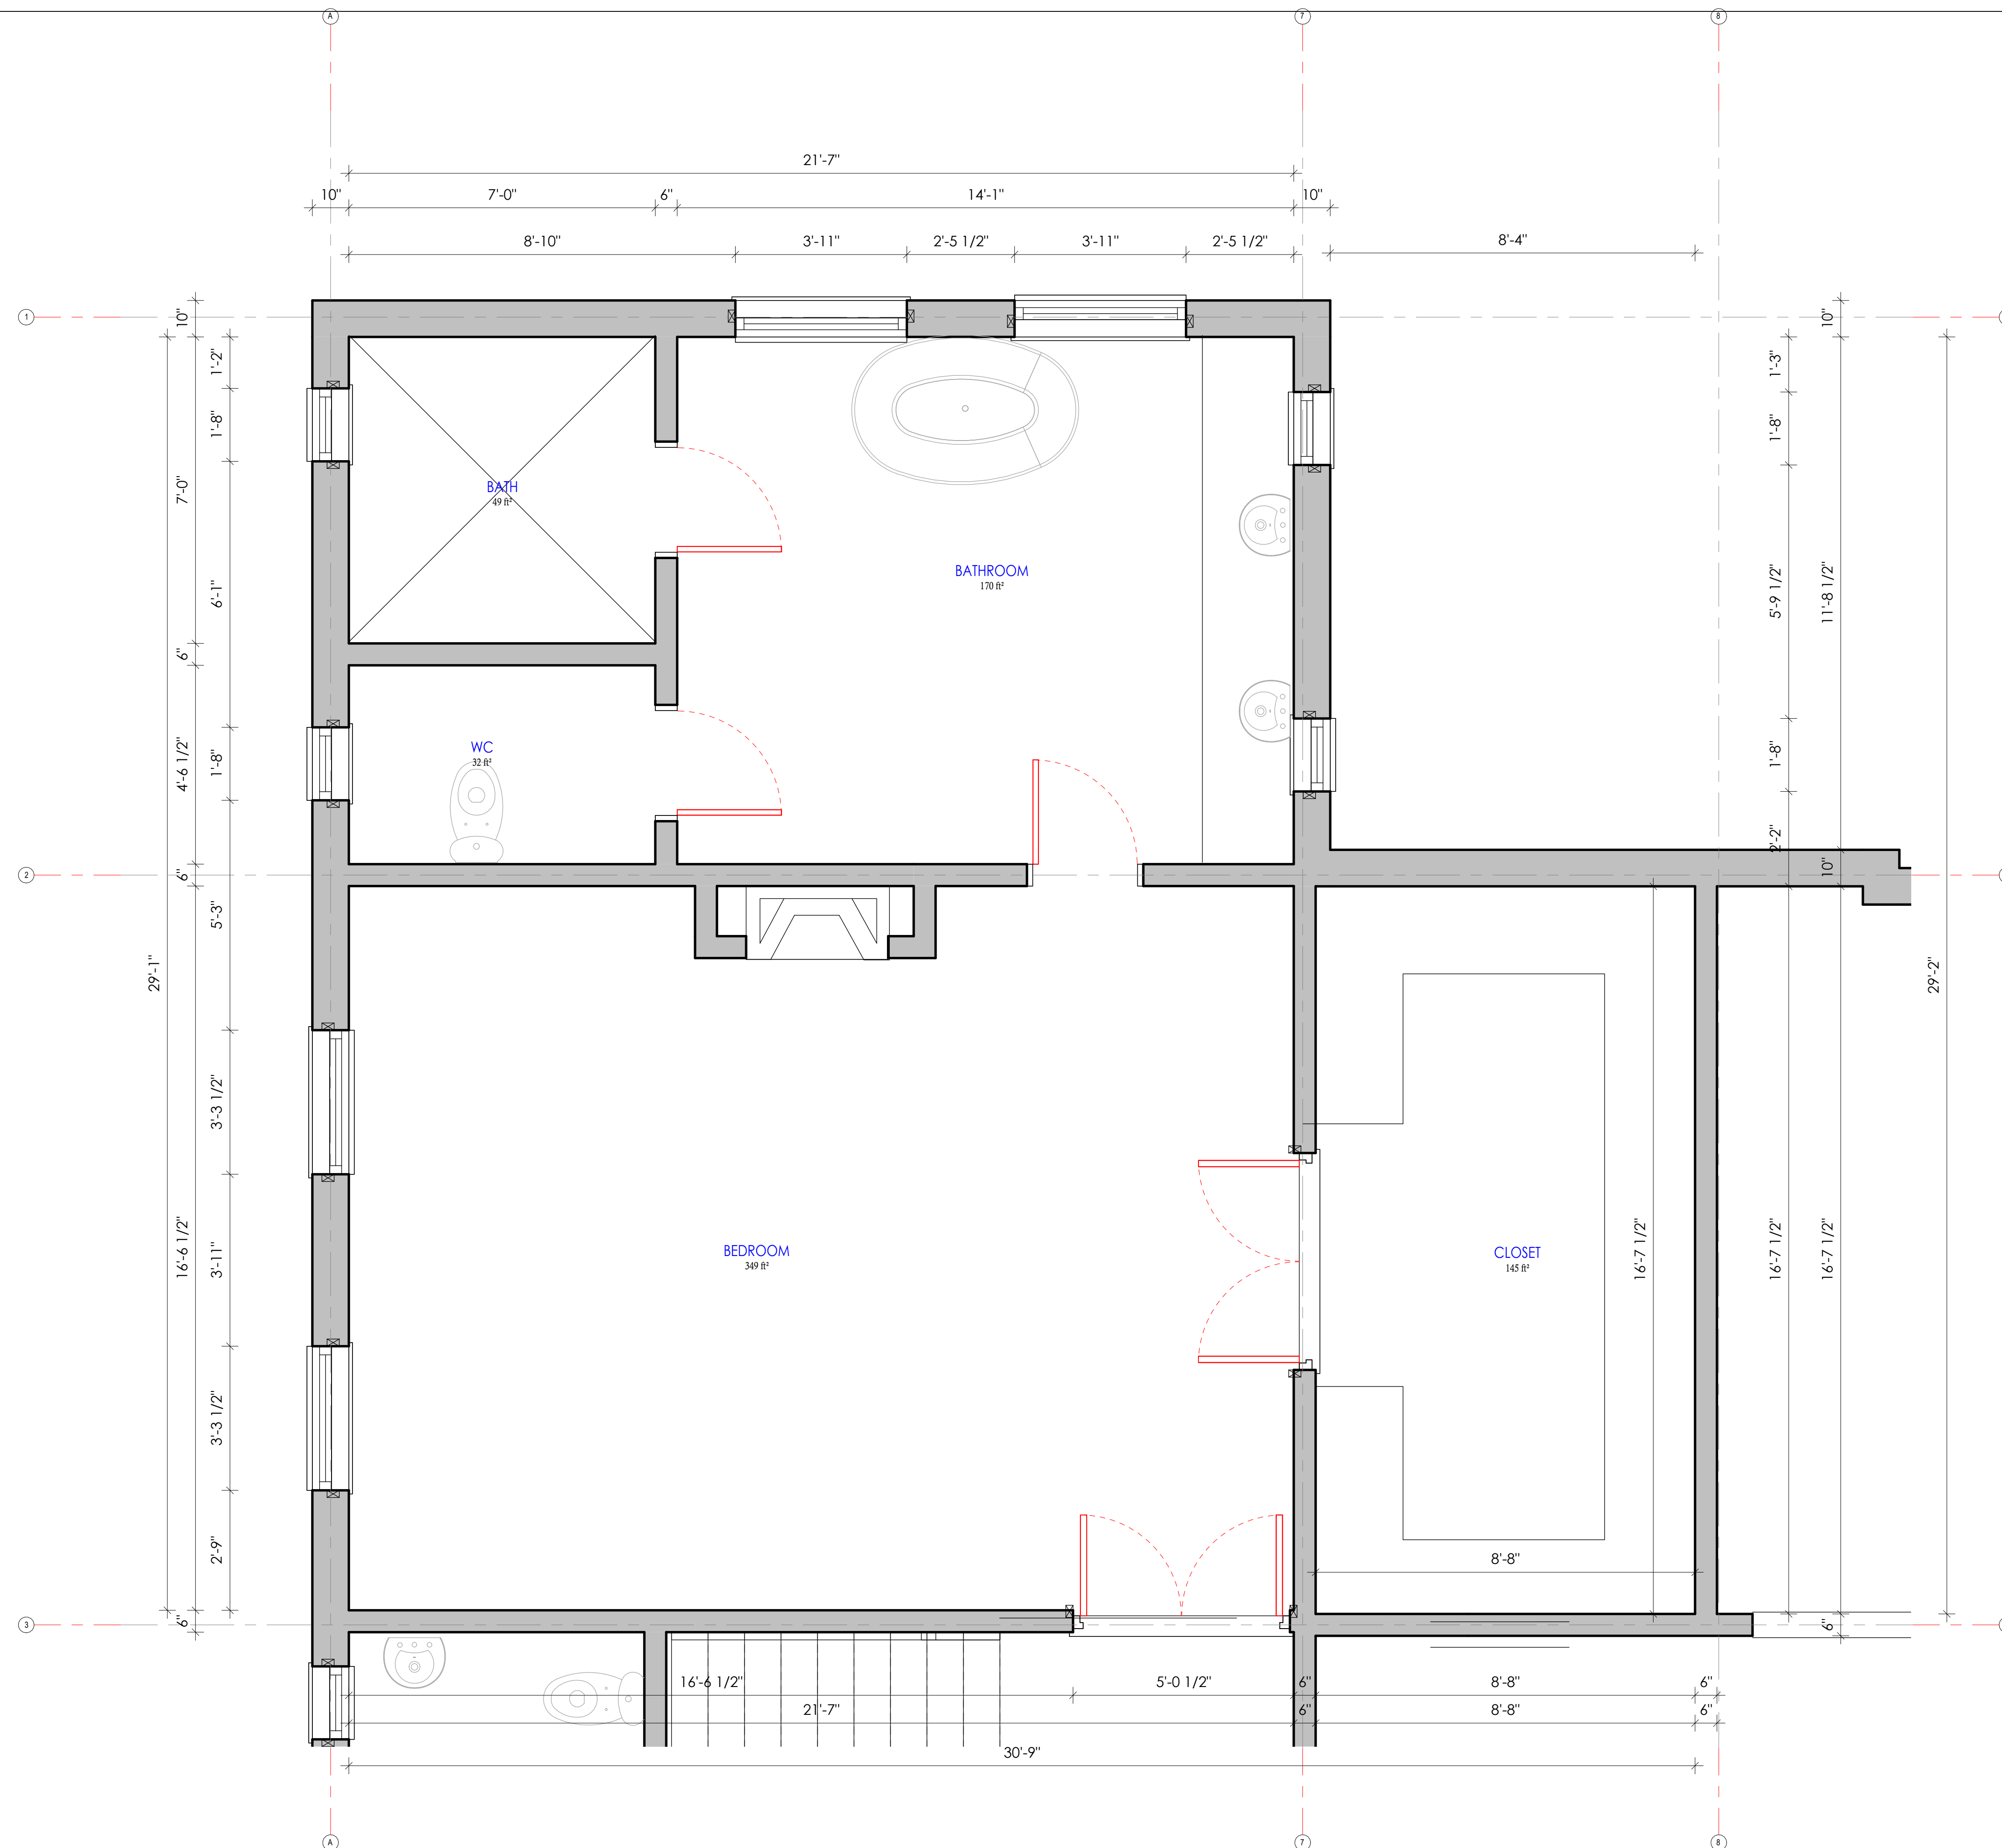

No.	Description	Date

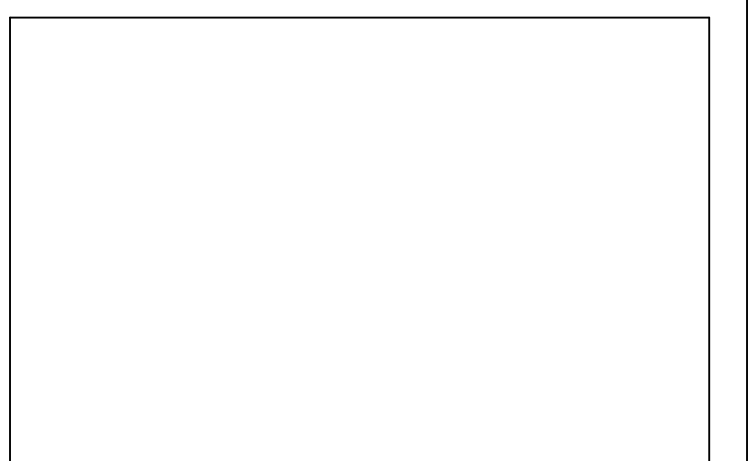

CALLOUT

Date                      APRIL 2024

Drawn by                Aaron DESIGN

**A104**


Scale                      1/2" = 1'-0"

**02 GROUND FLOOR PLAN - CALLOUT 7**  
1/2" = 1'-0"



Project Location

456 Gardenia  
St, 33756  
Belleair, FL,  
United  
States  
456  
Gardenia St

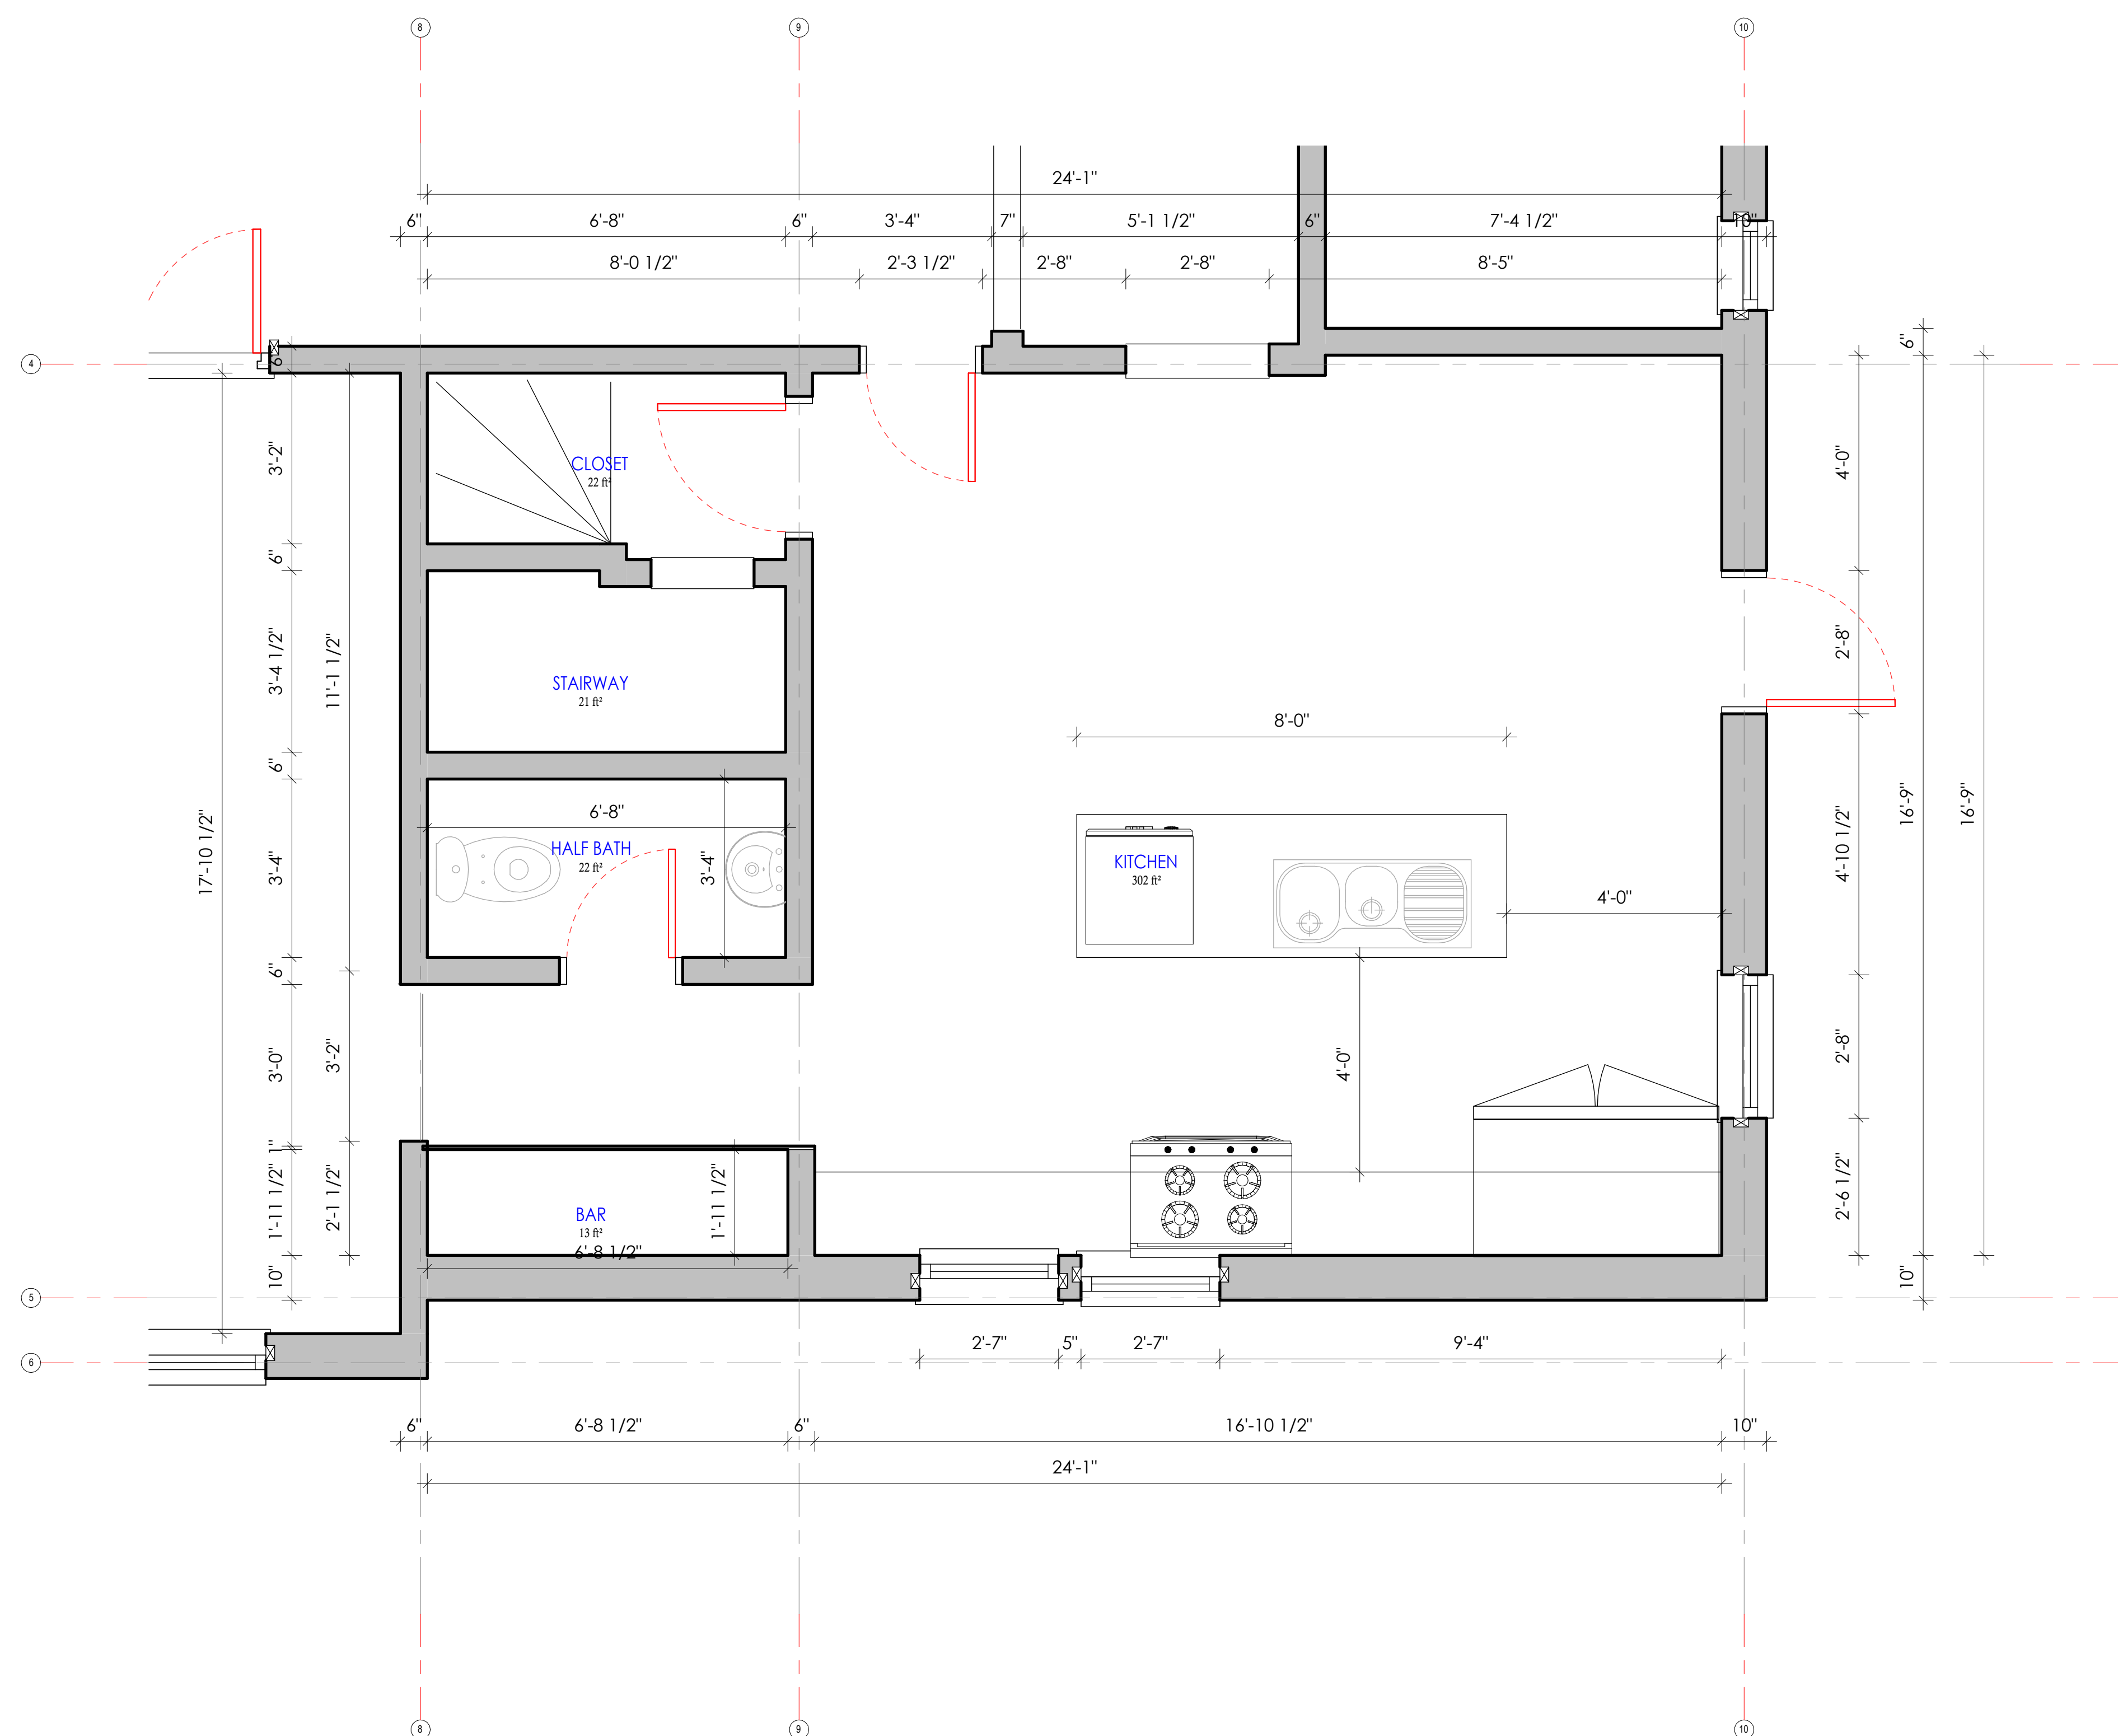

**02 GROUND FLOOR PLAN - CALLOUT B**  
1  
1/2" = 1'-0"

No.	Description	Date

CALLOUT

Date APRIL 2024

Drawn by Aaron DESIGN

A105

Scale 1/2" = 1'-0"

Project Location

456 Gardenia  
St, 33756  
Belleair, FL,  
United  
States  
456  
Gardenia St

No.	Description	Date


SECOND FLOOR

Date APRIL 2024

Drawn by Aaron DESIGN

A106


Scale 1/4" = 1'-0"

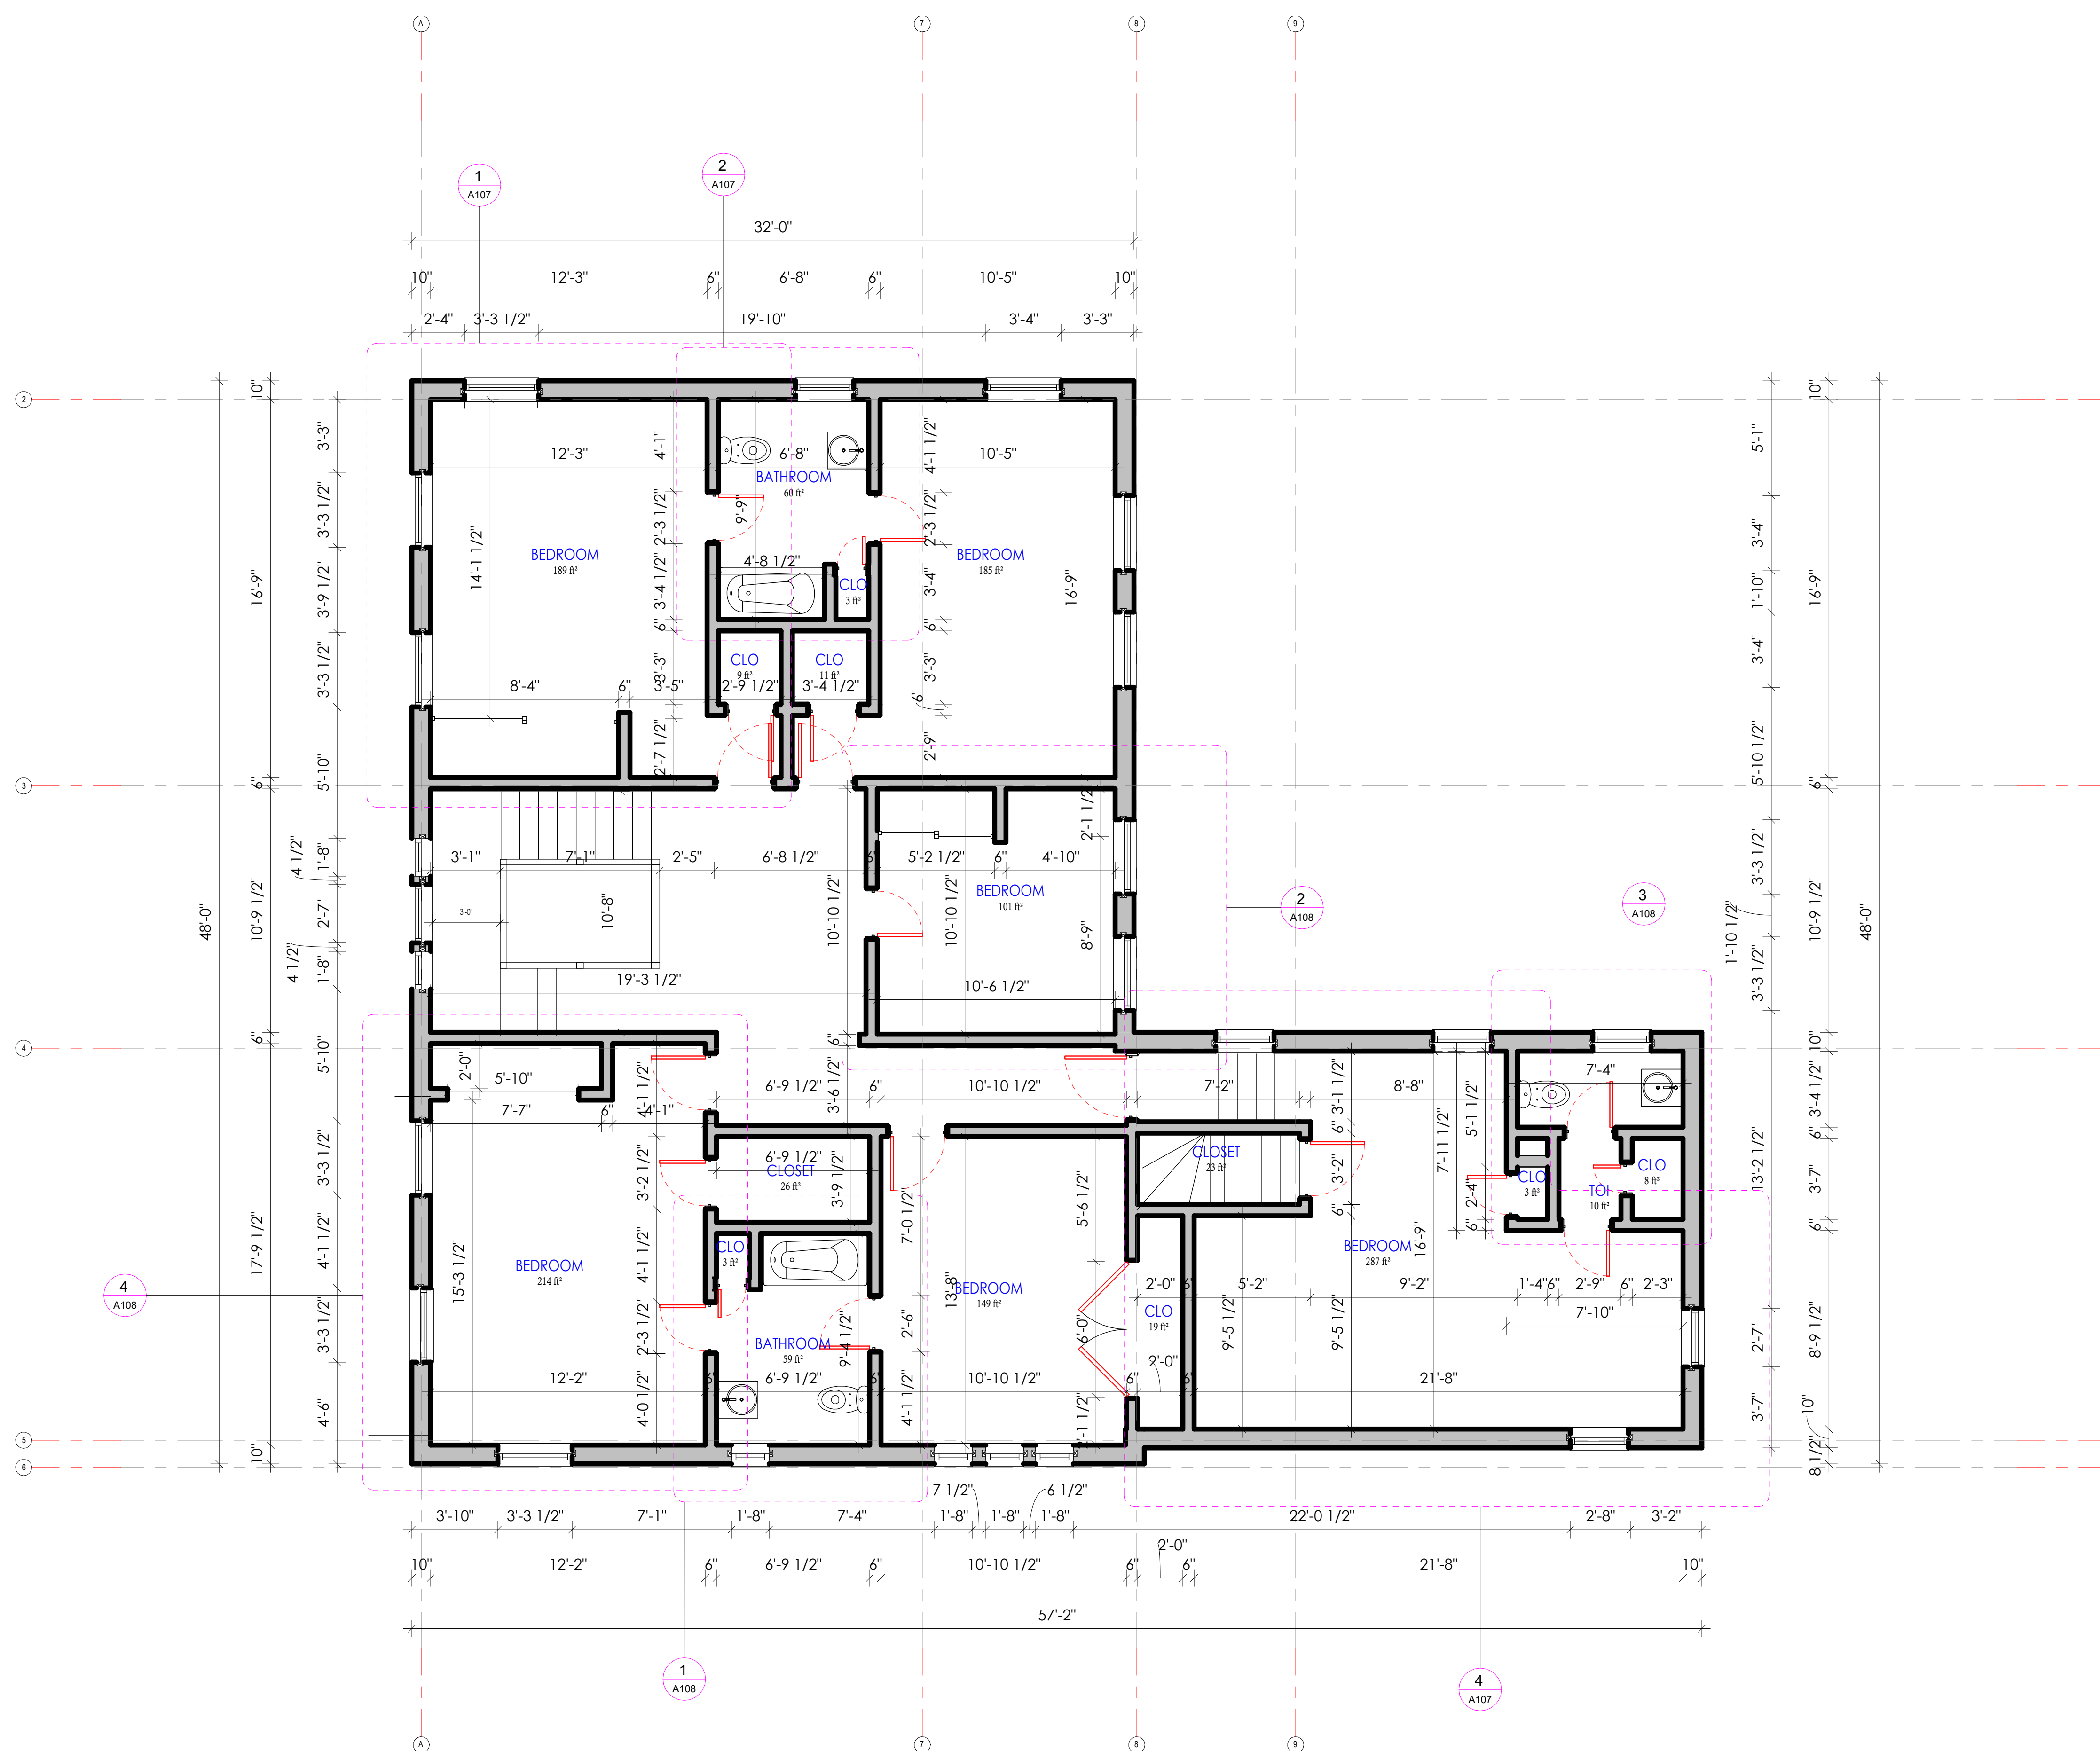




### Project Location


456 Gardenia  
St, 33756  
Belleair, FL,  
United  
States  
456  
Gardenia St

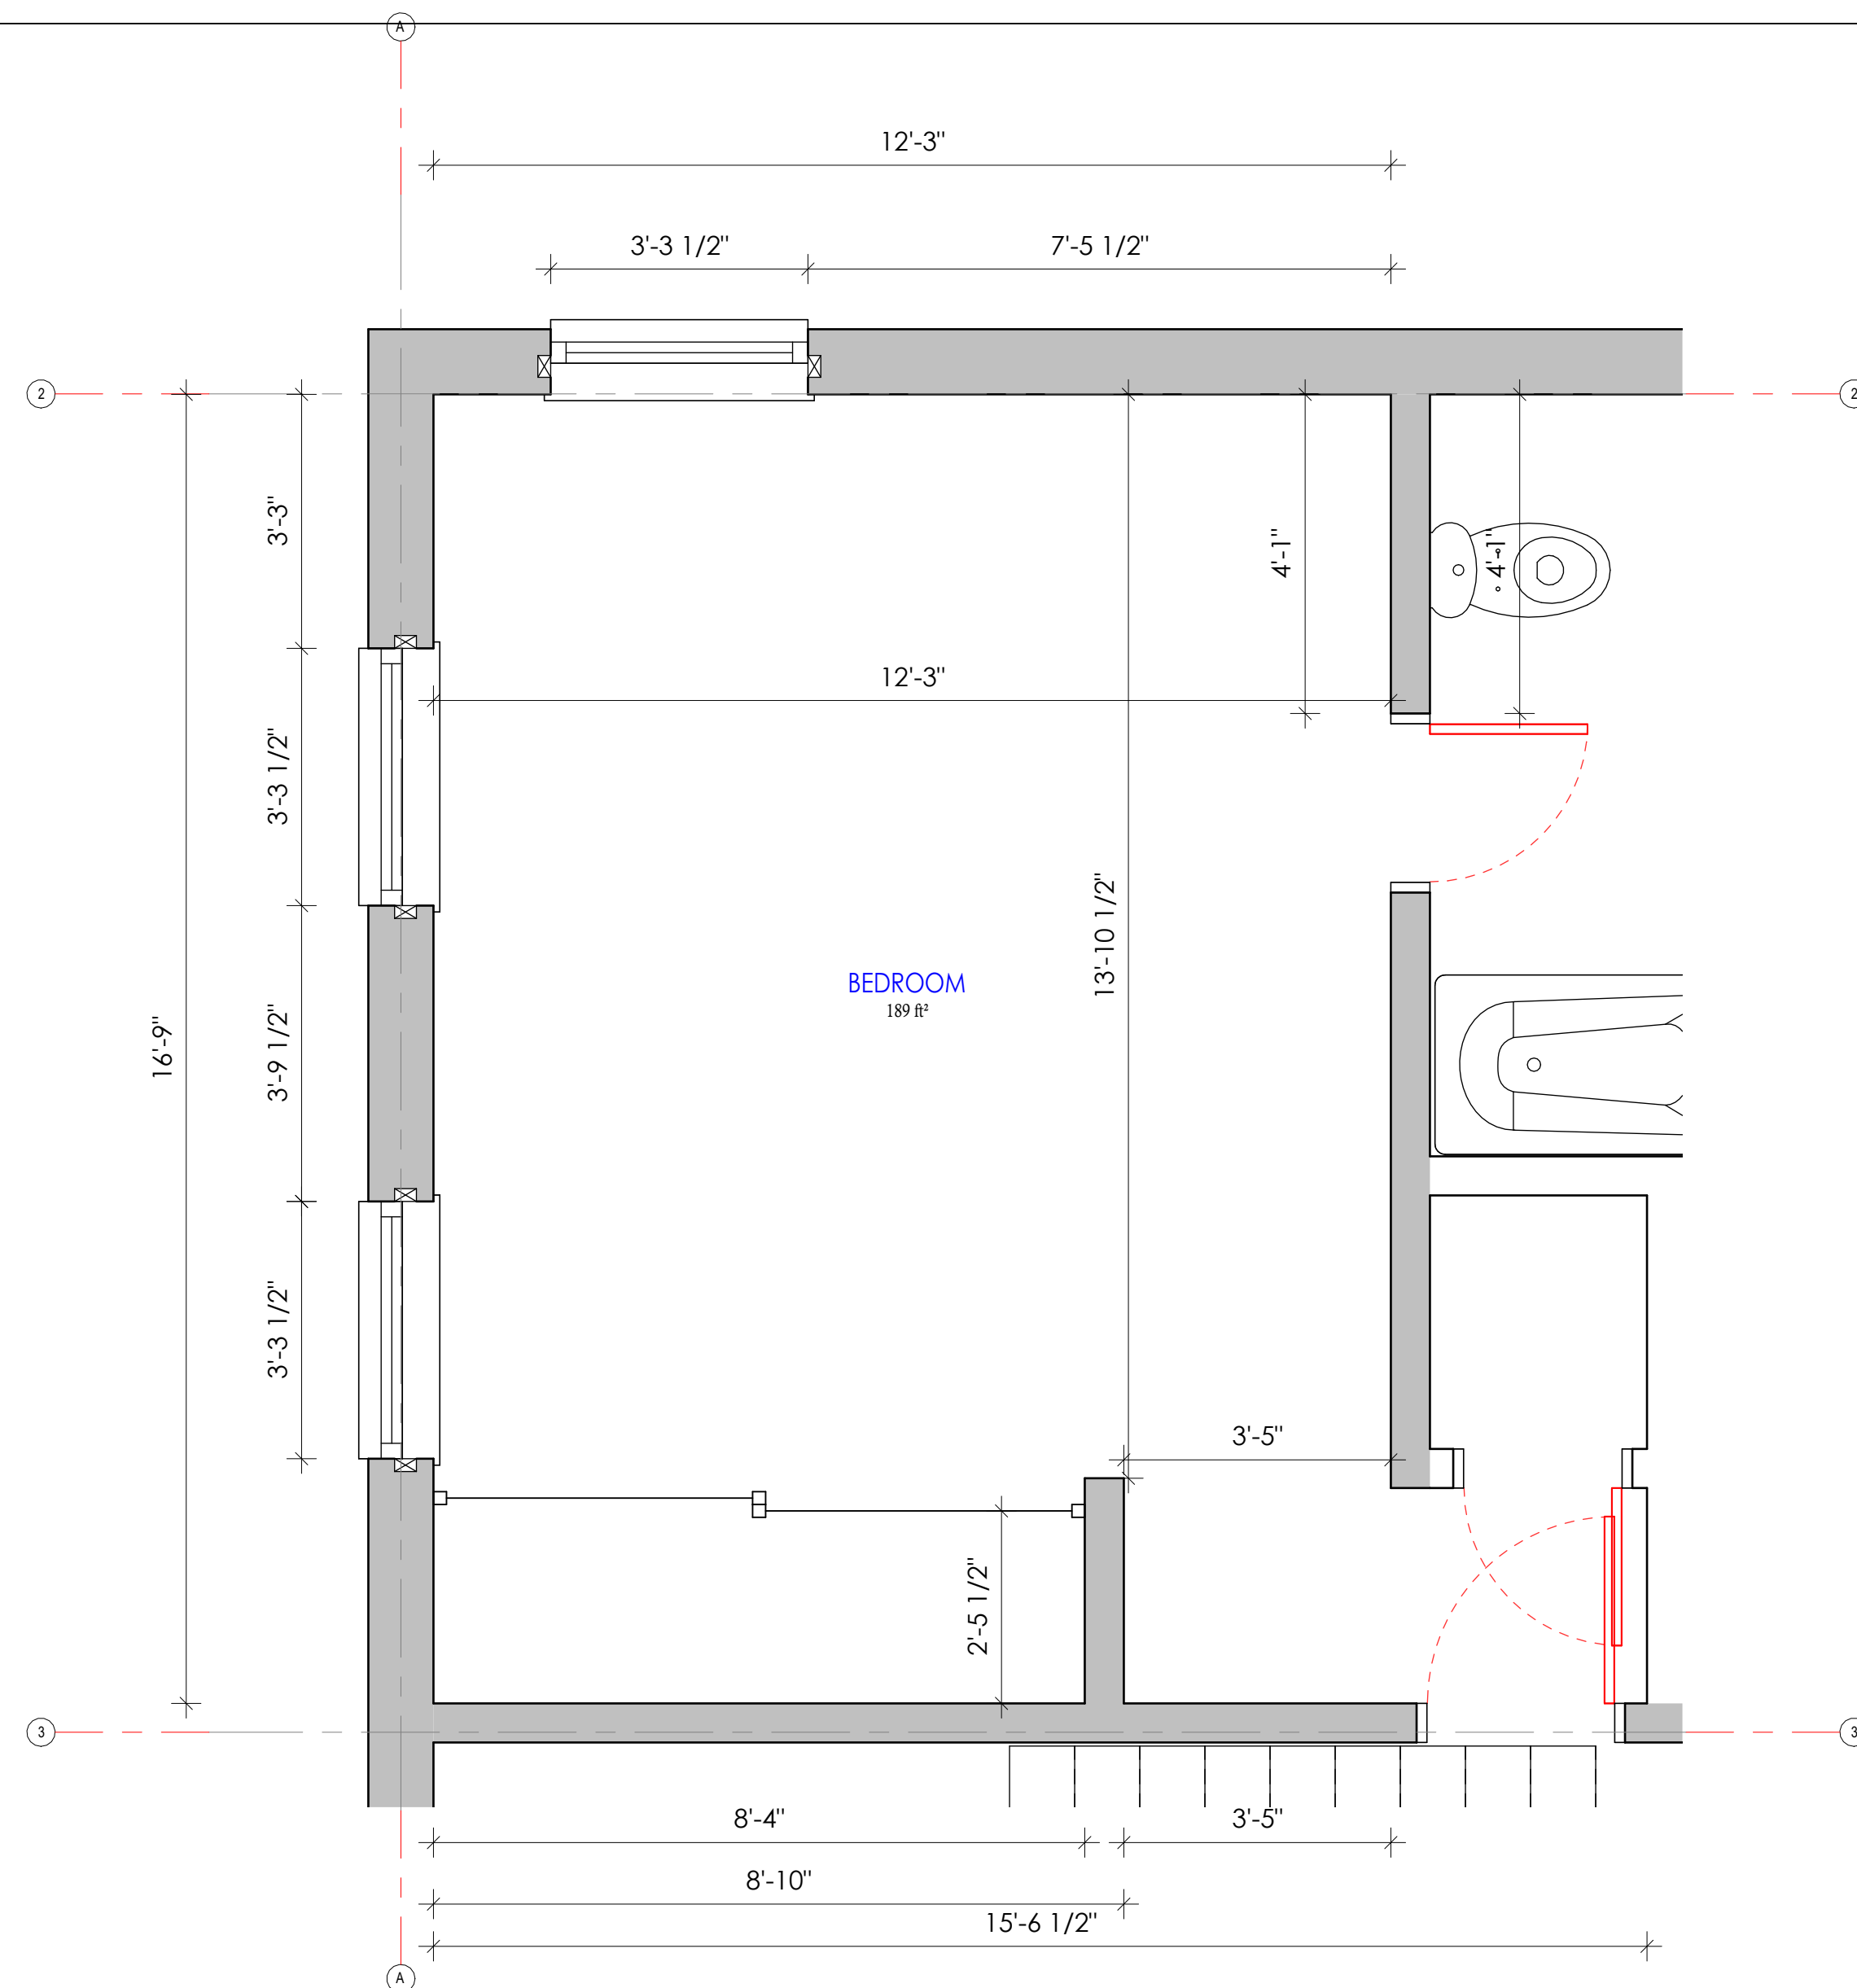

1 SECOND FLOOR - CALLOUT 1  
1/2" = 1'-0"

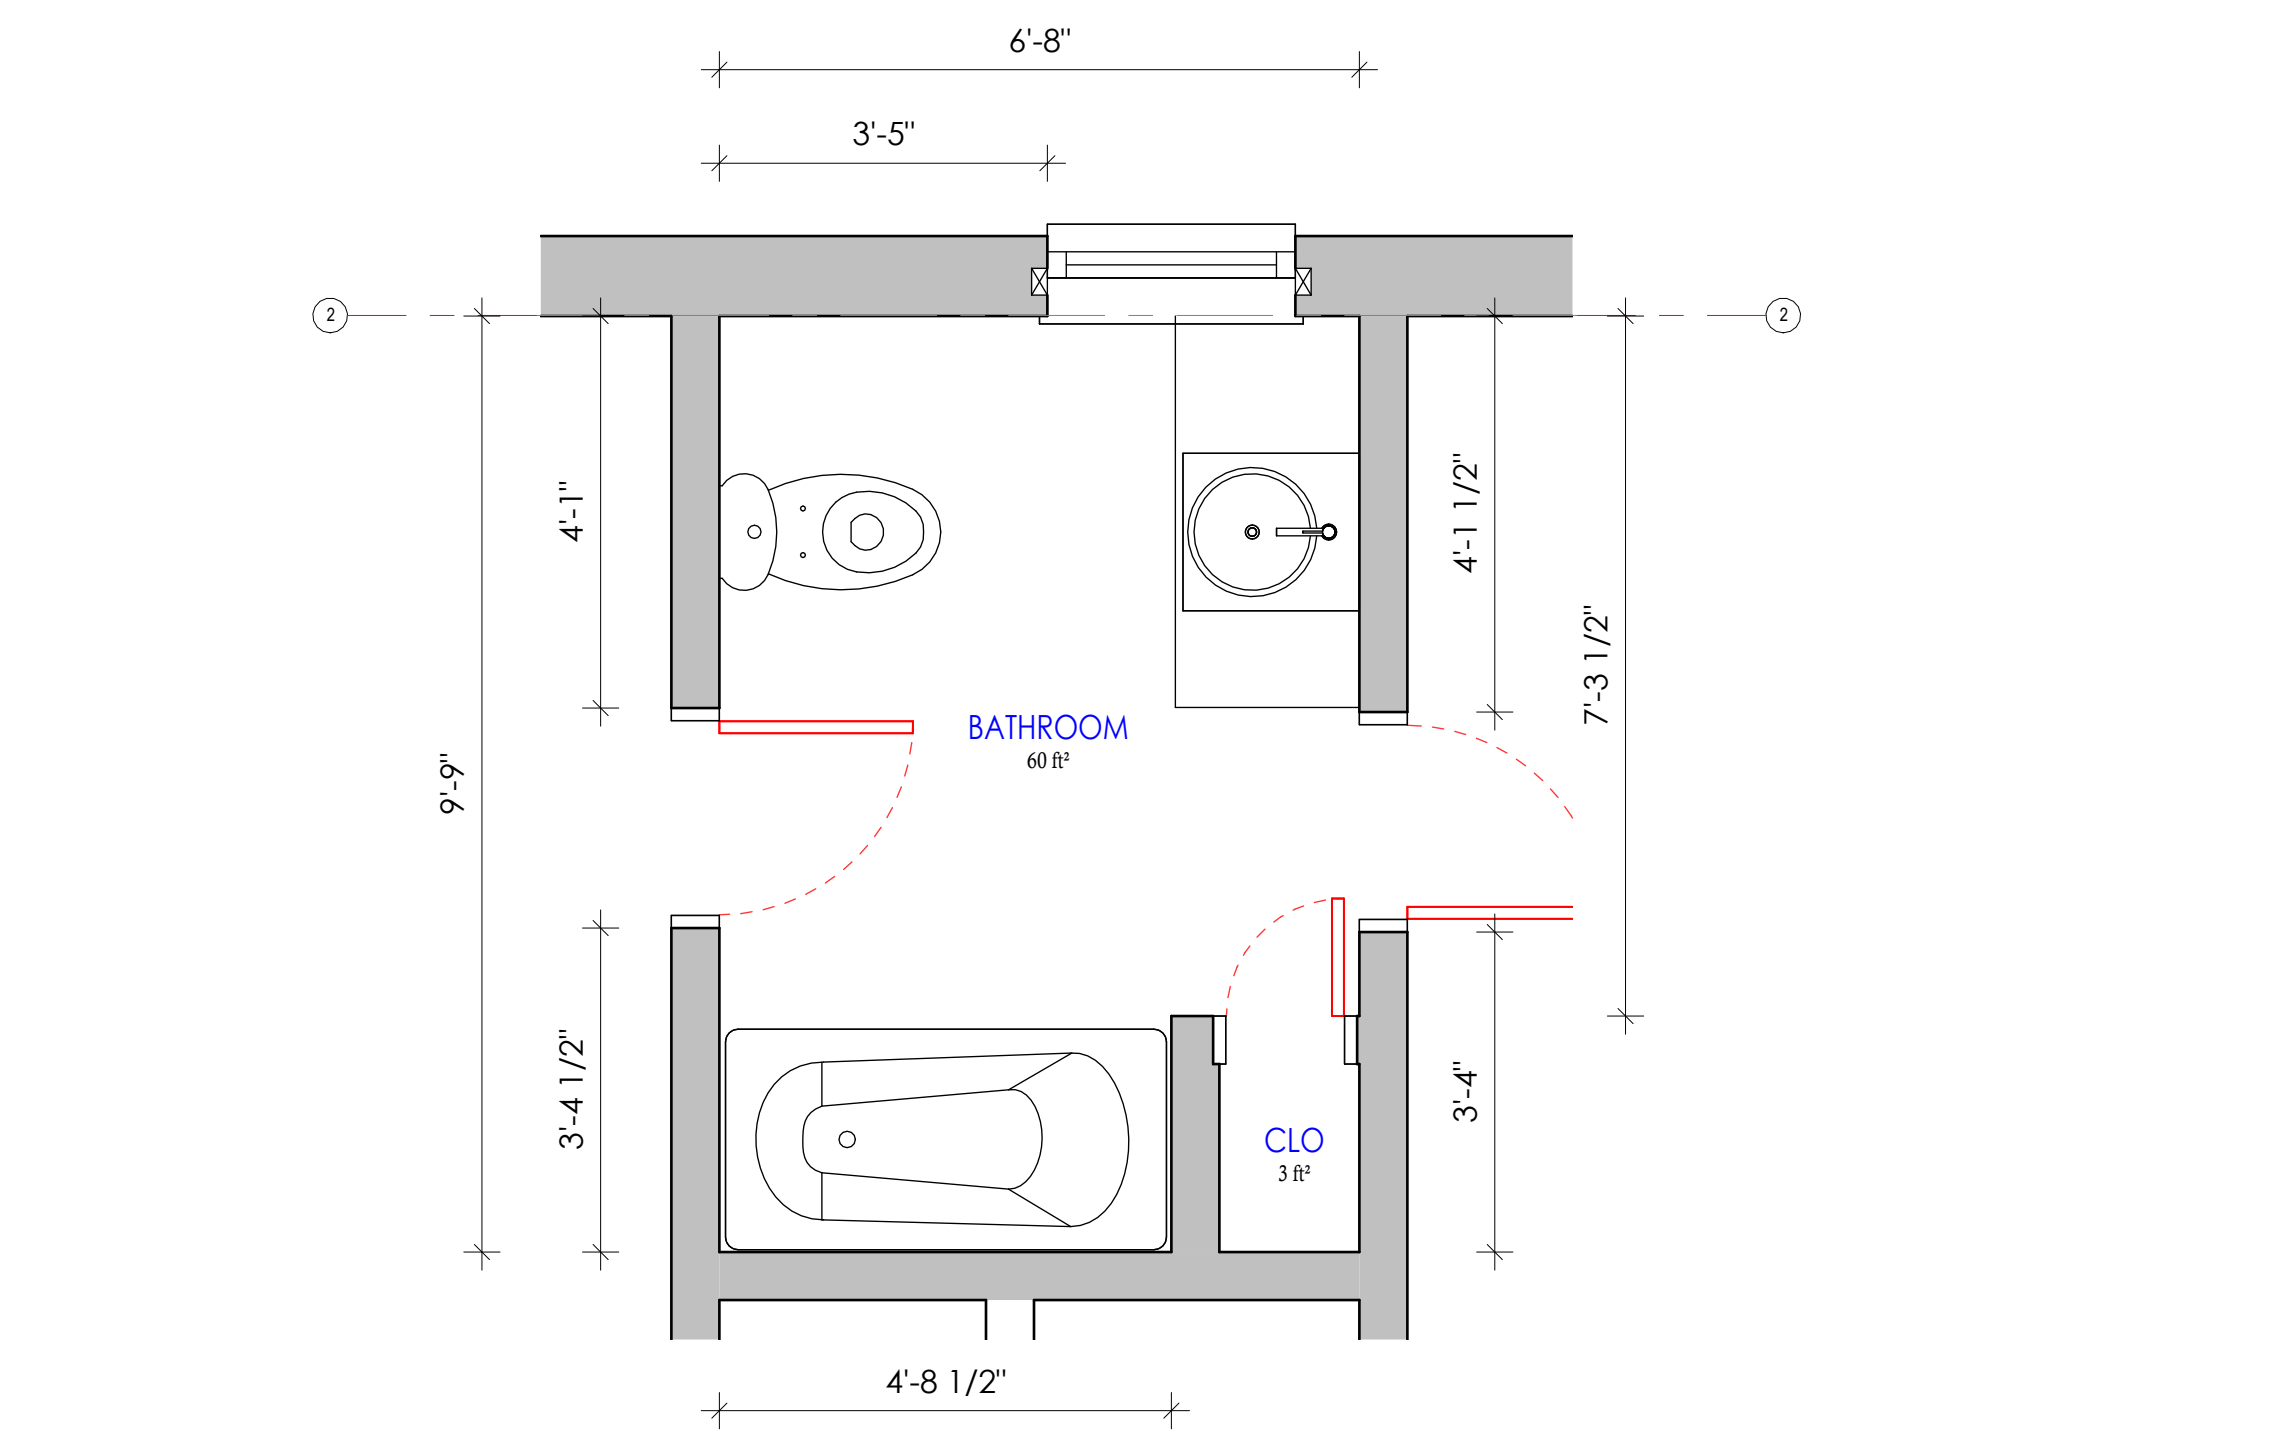

2 SECOND FLOOR - CALLOUT 2  
1/2" = 1'-0"

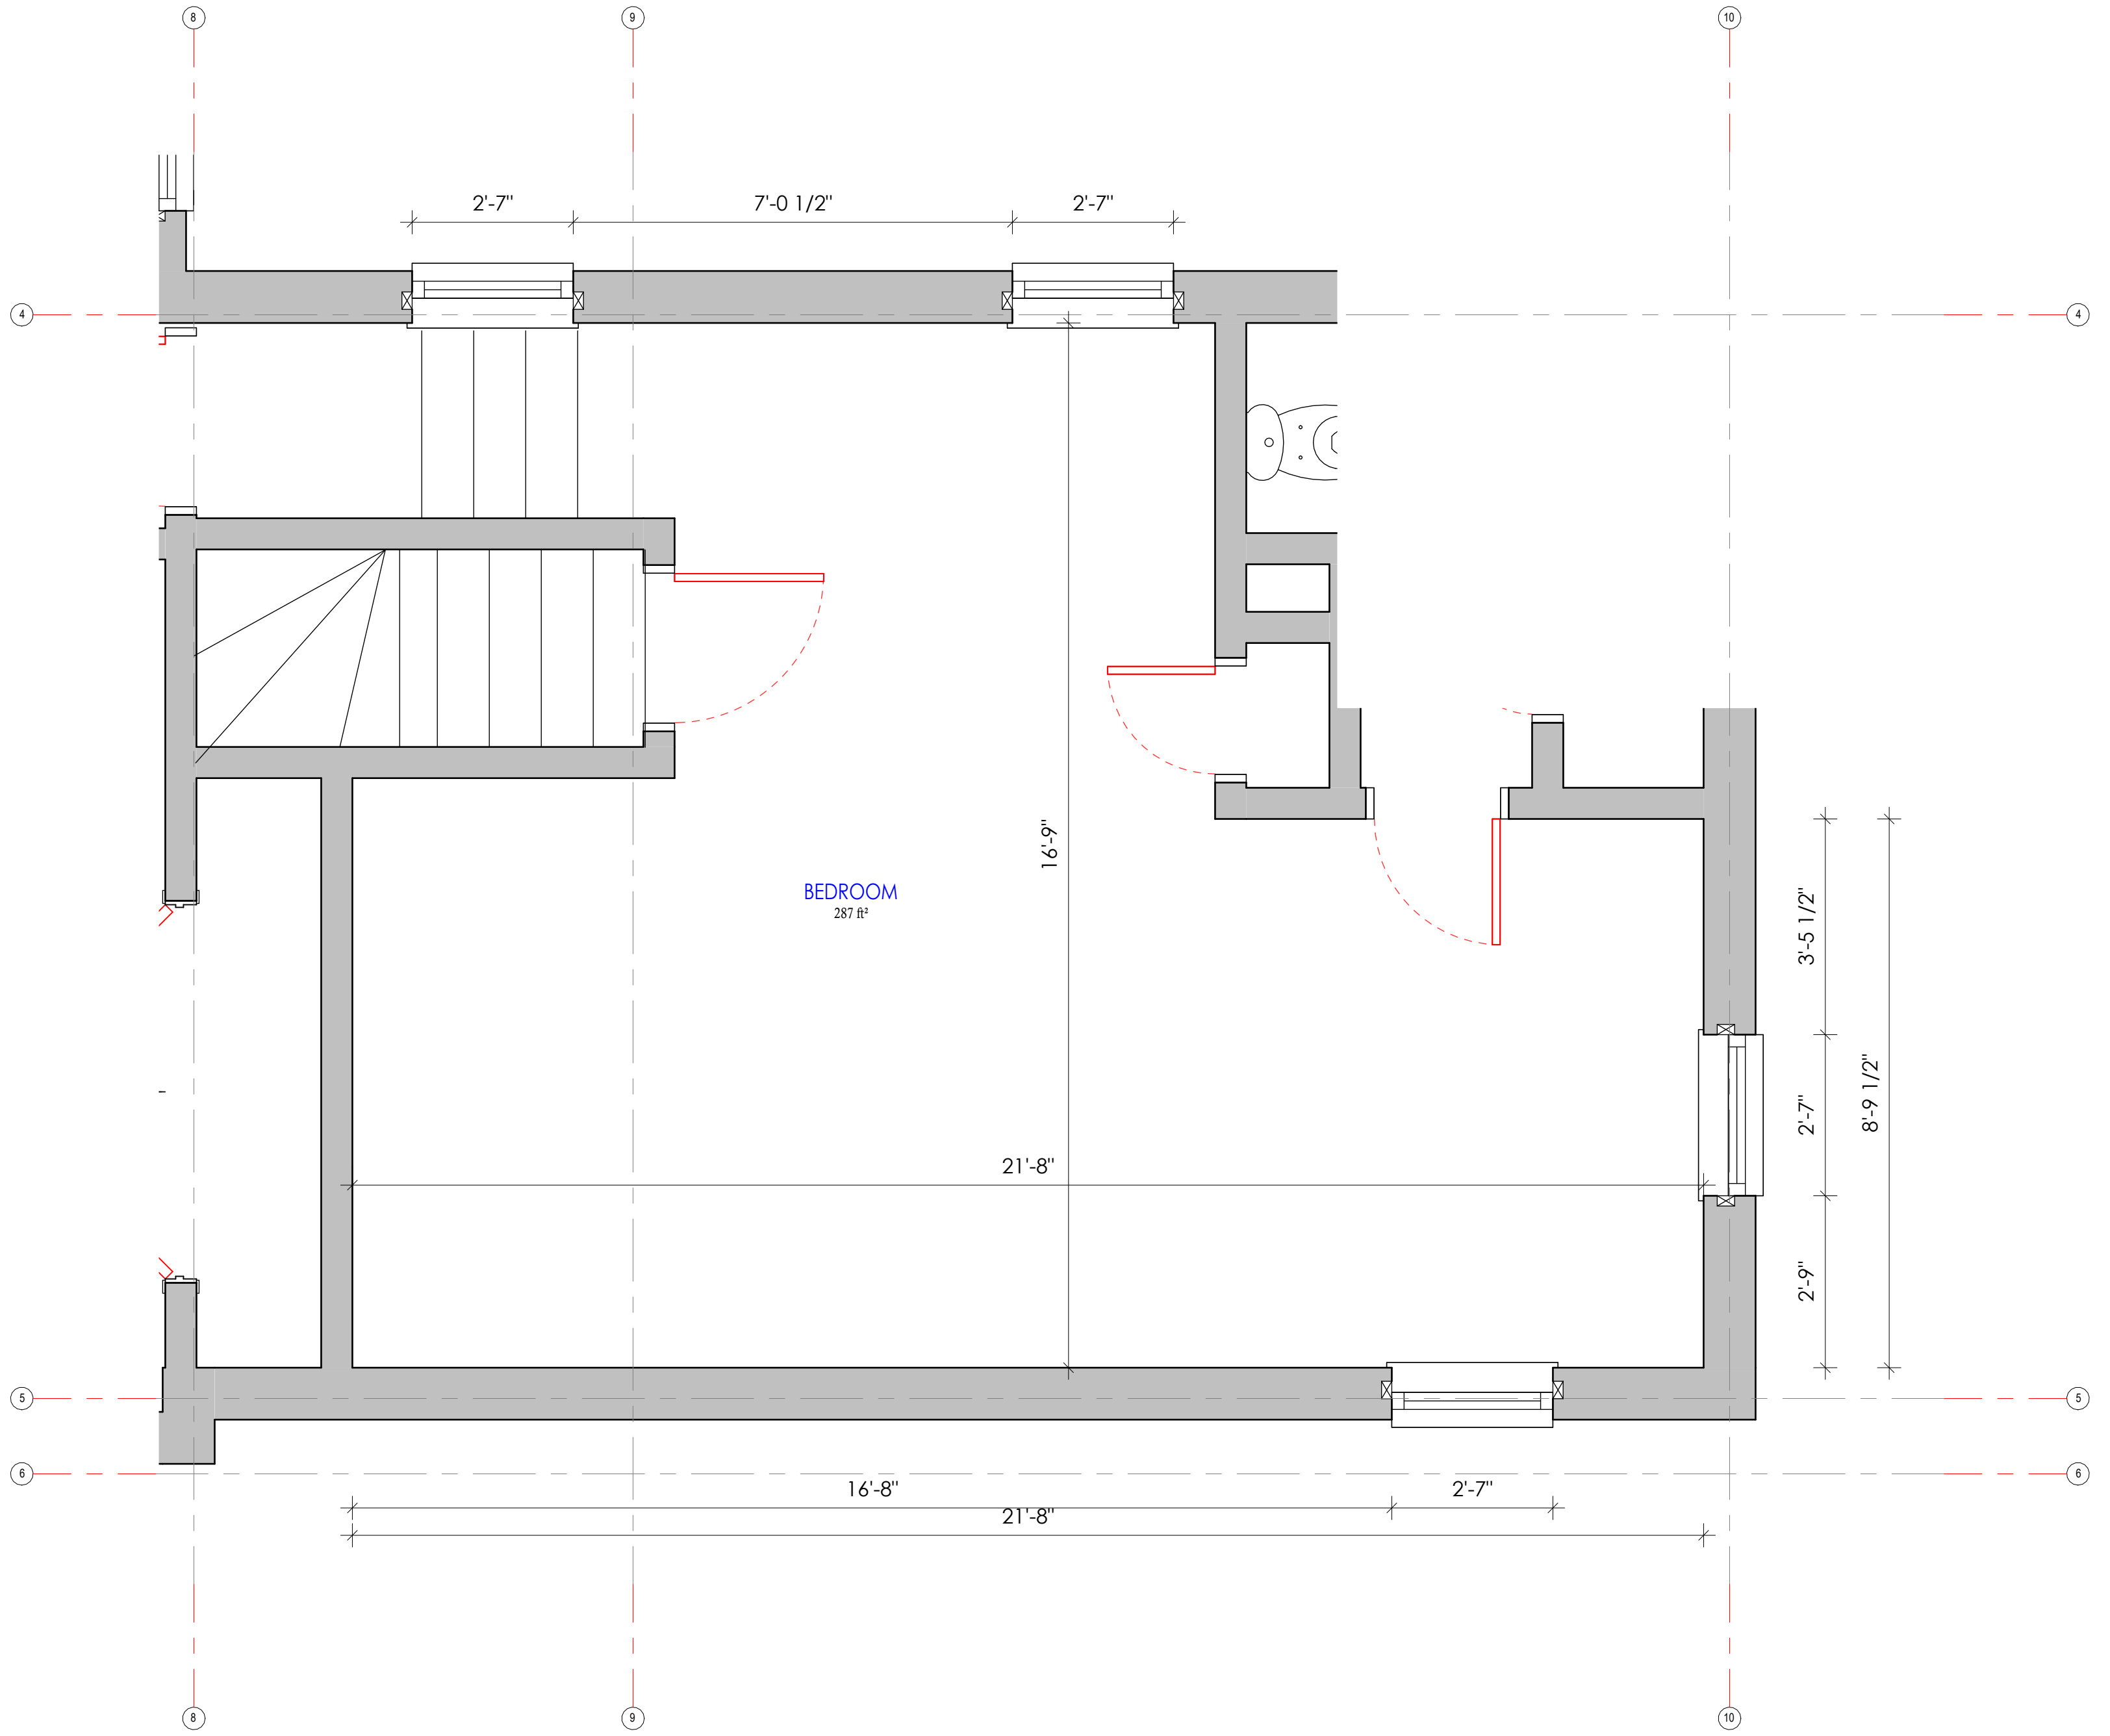

4 SECOND FLOOR - CALLOUT 4  
1/2" = 1'-0"

No.	Description	Date

**CALLOUT**

Date APRIL 2024

Drawn by Aaron DESIGN

# A107

Scale 1/2" = 1'-0"



